
# Vernon Historic Trail to Muscatatuck County Park DNR NLT 02-08 Spring 2024 Planned Construction Jennings County, Indiana

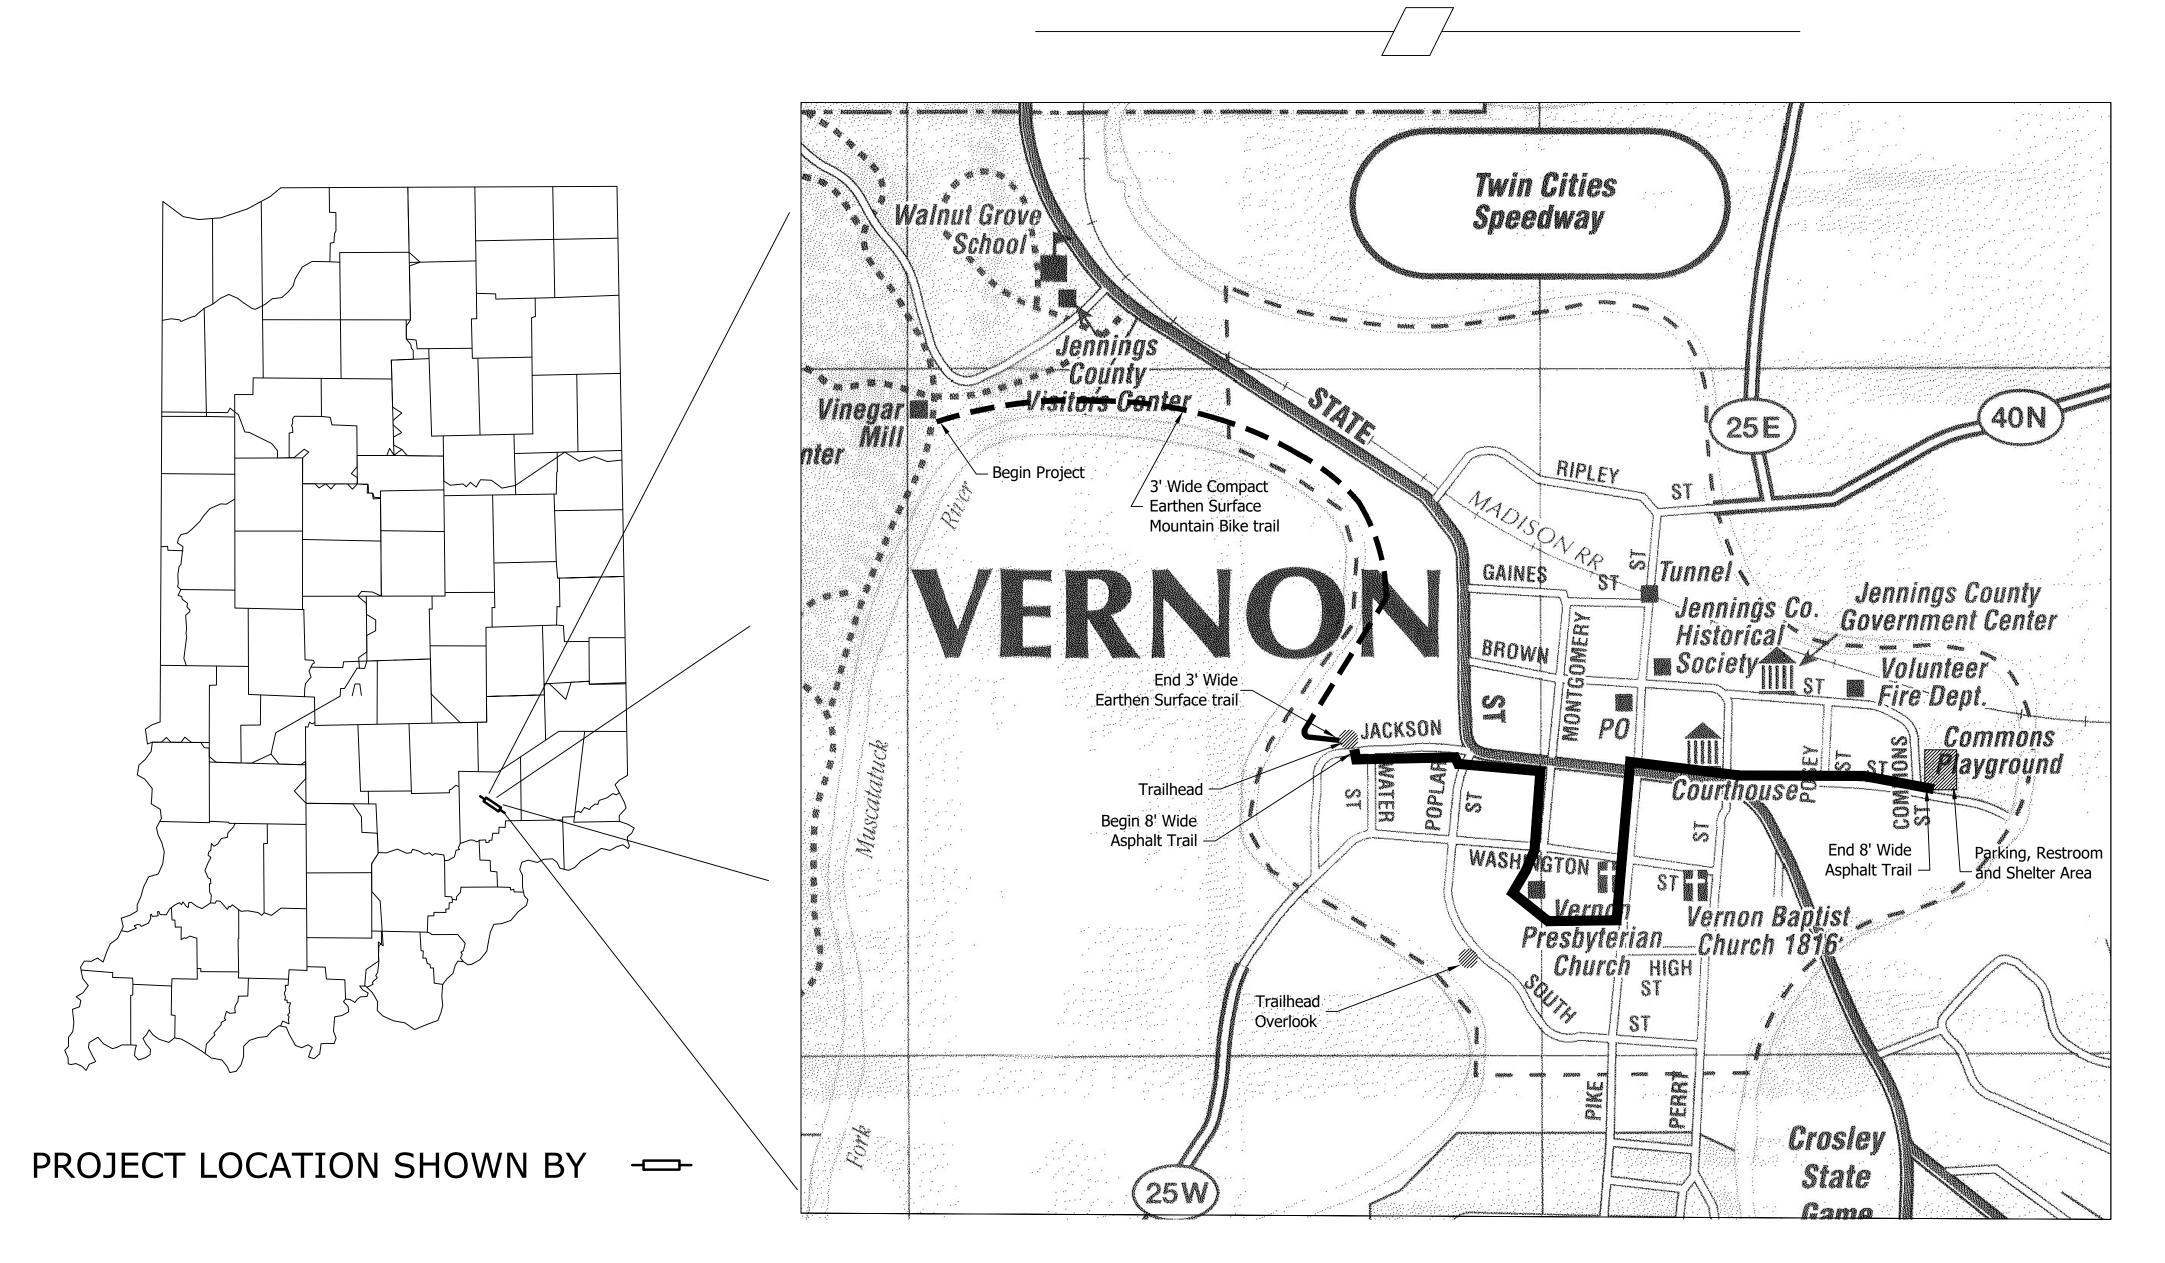

# PLANS PREPARED BY:

INDIANA UNDERGROUND

1-800-382-5544

NOTE: Utility Locations are shown based upon information (maps and paint marks) supplied by others, and there is no guarantee of the accuracy or completeness of said locations.

# FPBH, Inc. Engineers · Surveyors · Planners · Inspectors Offices in North Vernon, Seymour, & New Castle 72 Henry Street, PO Box 47 North Vernon, IN 47265 P: (812) 346-2045 Toll Free: 1-866-ENG-FPBH www.fpbhonline.com

# EXISTING FEATURES LEGEND

(APPLIES TO PLAN & PROFILE SHEETS)

OVERHEAD ELEC.	——— OE ———	STORM INVERT	Æ
OVERHEAD TELE.	OT	SANITARY MH	$\odot$
OVERHEAD CABLE	OTV	STORM MH	$\odot$
UNDERGRND. ELEC.	—— UE ——	STORM INLET	$\bigcirc$
WATER	w	FIRE HYDRANT	$\odot$
SANITARY SEWER	SAN	WATER METER	
FORCE MAIN	FM	WATER VALVE	$\bowtie$
STORM PIPE		POWER POLE	•
GAS	——— GAS ———	GUY WIRE	$\odot$
FLOWLINE	>	ELECTRIC BOX	E
TREE LINE		TELEPHONE POLE	$\odot$
BRUSH LINE		TELEPHONE BOX	T
FIBEROPTIC LINE	—— FO ——	GAS METER	G
	ſΩ	GAS VALVE	©
SIGN POLE SIGNAL POLE		RR SPIKE FND.	<u>^</u>
	$\odot$	RR SPIKE SET	
STREET LIGHT SIGNAL HANDHOLE	Ø	PK NAIL FND.	$\oplus$
		MAG NAIL SET	$\otimes$
MAILBOX	<b>₽</b>	IRON PIN FND.	(P
CLEANOUT	$\odot$	5/8" REBAR W/ CAP SET	•
BOLLARD	⊙ □	COUNTY MONUMENT	•
ELECTRIC METER	E	CORNER POST	·
DOWNSPOUT	+	BENCHMARK	X
DECIDUOUS TREE	*	TRAVERSE	<u>^</u>
EVERGREE TREE	*	1/2" REBAR SET	$\otimes$
STUMP	$\odot$	R/W MONUMENT	$\blacksquare$
		MAG NAIL FND.	$\otimes$

TOWN OF VERNON
VERNON MUSCATATUCK TRAIL
2312939
OCTOBER 2, 2023

PREPARED FOR: TO PROJECT DESCRIPTION: VEF FILE NUMBER: 231

FILE FILE DESIGNATION OF STATE OF STATE

# UTILITIES



Per Indiana State Law IC-8-1-26-16, It is against the law to excavate without notifying the underground location service two full working days before commencing work.

INDIANA UNDERGROUND 1-800-382-5544 OR CALL 811 24 HOURS A DAY, 7 DAYS A WEEK

# UTILITY NOTES

NOTE 1: All utilities depicted on these plans are at "Quality Level B".

NOTE 2: "Quality Level B" utility locates are based on markings provided by others. There is no guarantee as to the accuracy or completeness of these markings. The exact depth of existing utilities is uncertain and should be field verified by contractor as needed. Existing utility depths shown on profiles and cross sections are shown for information purposes only and are not to be taken as true depths.

NOTE 3: Utility quality level designations are based on ASCE 38-02 (Standard Guideline for the Collection and Depiction of Existing Subsurface Utility Data).

# GENERAL NOTES

- 1. All earth cut and fill slopes shall be mulched seeded unless noted otherwise in the plans to have nursery sodding placed.
- 2. Where new trail is to be placed where sidewalk presently exists, the sidewalk shall be removed.

# CONSTRUCTION LEGEND

- MILE MARKER
- TRAIL DIRECTIONAL MARKER
- WOOD BOLLARD
- WOOD BOLLARD, REMOVABLE
- KIOSK, INFORMATION
- GATE, TRAIL
- CONCRETE PAVED AREA

	Sheet List Table
Sheet Number	Sheet Title
G-001	TITLE SHEET
G-002	INDEX & GENERAL INFORMATION
C-000	TRAIL LINE DIAGRAM
C-001	TYPICAL SECTION - VERNON PAVED SECTION -Mod
C-002	TYPICAL SECTION - RIVER HIKING & MOUNTAIN BIKE SECTION
C-100	PLAN SHEET LAYOUT
C-101	PLAN & PROFILE No.1
C-102	PLAN & PROFILE No.2
C-103	PLAN & PROFILE No.3
C-104	PLAN & PROFILE No.4
C-105	PLAN & PROFILE No.5
C-106	PLAN & PROFILE No.6
C-107	PLAN & PROFILE No.7
C-108	PLAN & PROFILE No.8
C-108A	HISTORIC STRUCTURE CROSS SECTION NO.1
C-109	PLAN & PROFILE No.9
C-110	PLAN & PROFILE No.10
C-111	PLAN & PROFILE No.11
C-112	PLAN & PROFILE No.12
C-113	PLAN & PROFILE No.13
C-114	PLAN & PROFILE No.14
CS-100	FOOT BRIDGE SITE PLAN
CS-101	TRAILHEAD - WATER ST
CS-102	HIGH SCHOOL OVERLOOK
CS-103	SR 3 CROSSING
CS-104	COMMONS PARK
CD-100	DETAILS
CD-101	CONCRETE MASONRY UNIT RETAINING WALL
CD-102	FOOT BRIDGE NO.1
CD-103	FOOT BRIDGE NO.2
CD-104	FOOT BRIDGE NO.3
CD-105	STAIRCASE
CD-106	STEP AND RUN
CD-107	BOLLARDS
CD-108	SIGNS & MARKERS
CD-109	TRAIL DIRECTIONAL MARKER
CD-110	REASSURANCE MARKERS
CD-111	RIVER OVERLOOK STRUCTURE
CD-112	VERNON HIGH SCHOOL SHELTER
CD-113	COMMONS SHELTER
CD-114	TRAIL KIOSK
A-101	COMMONS RESTROOM


Sneet List Table					
<b>Sheet Number</b>	Sheet Title				
G-001	TITLE SHEET				
G-002	INDEX & GENERAL INFORMATION				
C-000	TRAIL LINE DIAGRAM				
C-001	TYPICAL SECTION - VERNON PAVED SECTION -Mod				
C-002	TYPICAL SECTION - RIVER HIKING & MOUNTAIN BIKE SECTION				
C-100	PLAN SHEET LAYOUT				
C-101	PLAN & PROFILE No.1				
C-102	PLAN & PROFILE No.2				
C-103	PLAN & PROFILE No.3				
C-104	PLAN & PROFILE No.4				
C-105	PLAN & PROFILE No.5				
C-106	PLAN & PROFILE No.6				
C-107	PLAN & PROFILE No.7				
C-108	PLAN & PROFILE No.8				
C-108A	HISTORIC STRUCTURE CROSS SECTION NO.1				
C-109	PLAN & PROFILE No.9				
C-110	PLAN & PROFILE No.10				
C-111	PLAN & PROFILE No.11				
C-112	PLAN & PROFILE No.12				
C-113	PLAN & PROFILE No.13				
C-114	PLAN & PROFILE No.14				
CS-100	FOOT BRIDGE SITE PLAN				
CS-101	TRAILHEAD - WATER ST				
CS-102	HIGH SCHOOL OVERLOOK				
CS-103	SR 3 CROSSING				
CS-104	COMMONS PARK				
CD-100	DETAILS				
CD-101	CONCRETE MASONRY UNIT RETAINING WALL				
CD-102	FOOT BRIDGE NO.1				
CD-103	FOOT BRIDGE NO.2				
CD-104	FOOT BRIDGE NO.3				
CD-105	STAIRCASE				
CD-106	STEP AND RUN				
CD-107	BOLLARDS				
CD-108	SIGNS & MARKERS				
CD-109	TRAIL DIRECTIONAL MARKER				
CD-110	REASSURANCE MARKERS				
CD-111	RIVER OVERLOOK STRUCTURE				
CD-112	VERNON HIGH SCHOOL SHELTER				
CD-113	COMMONS SHELTER				
CD-114	TRAIL KIOSK				
A-101	COMMONS RESTROOM				

REVISIONS							
SHEET NO.	DATE	REVISED					

# GENERAL NOTE:

All construction to meet or exceed all state, local, and federal codes & requirements, including but not limited to current INDOT ISBH, IDEM, OSHA, local requirements & codes. The drawings & specs. that make up the work of this project are interrelated 8 dependent on every other drawing and spec. section. The contractor shall review all other specs., drawing & addendum (i applicable) to coordinate all work that relates to this project. If an item is drawn or specified on any spec. section or drawing it shall be as if it were part of this work and shall be provided for in the contract.

1. This sheet is to be: 22" X 34"

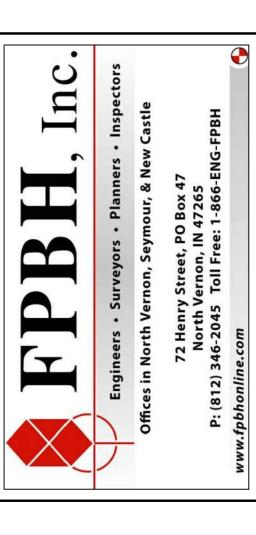

SCALE: 1" = 20'									
DRAWN E	BY: CK								
CHECKED	BY: SG								
DATE: O	CTOBER 2, 20	)23							
Revision	Drawn By	Date							
TILE NO.	2212020								


FILE NO: 2312939 CLIENT NAME: TOWN OF VERNON


PROJECT DESCRIPTION: VERNON MUSCATATUCK TRAIL

SHEET TITLE:


INDEX & GENERAL INFORMATION

DESIGN PHASE: OWNER REVIEW

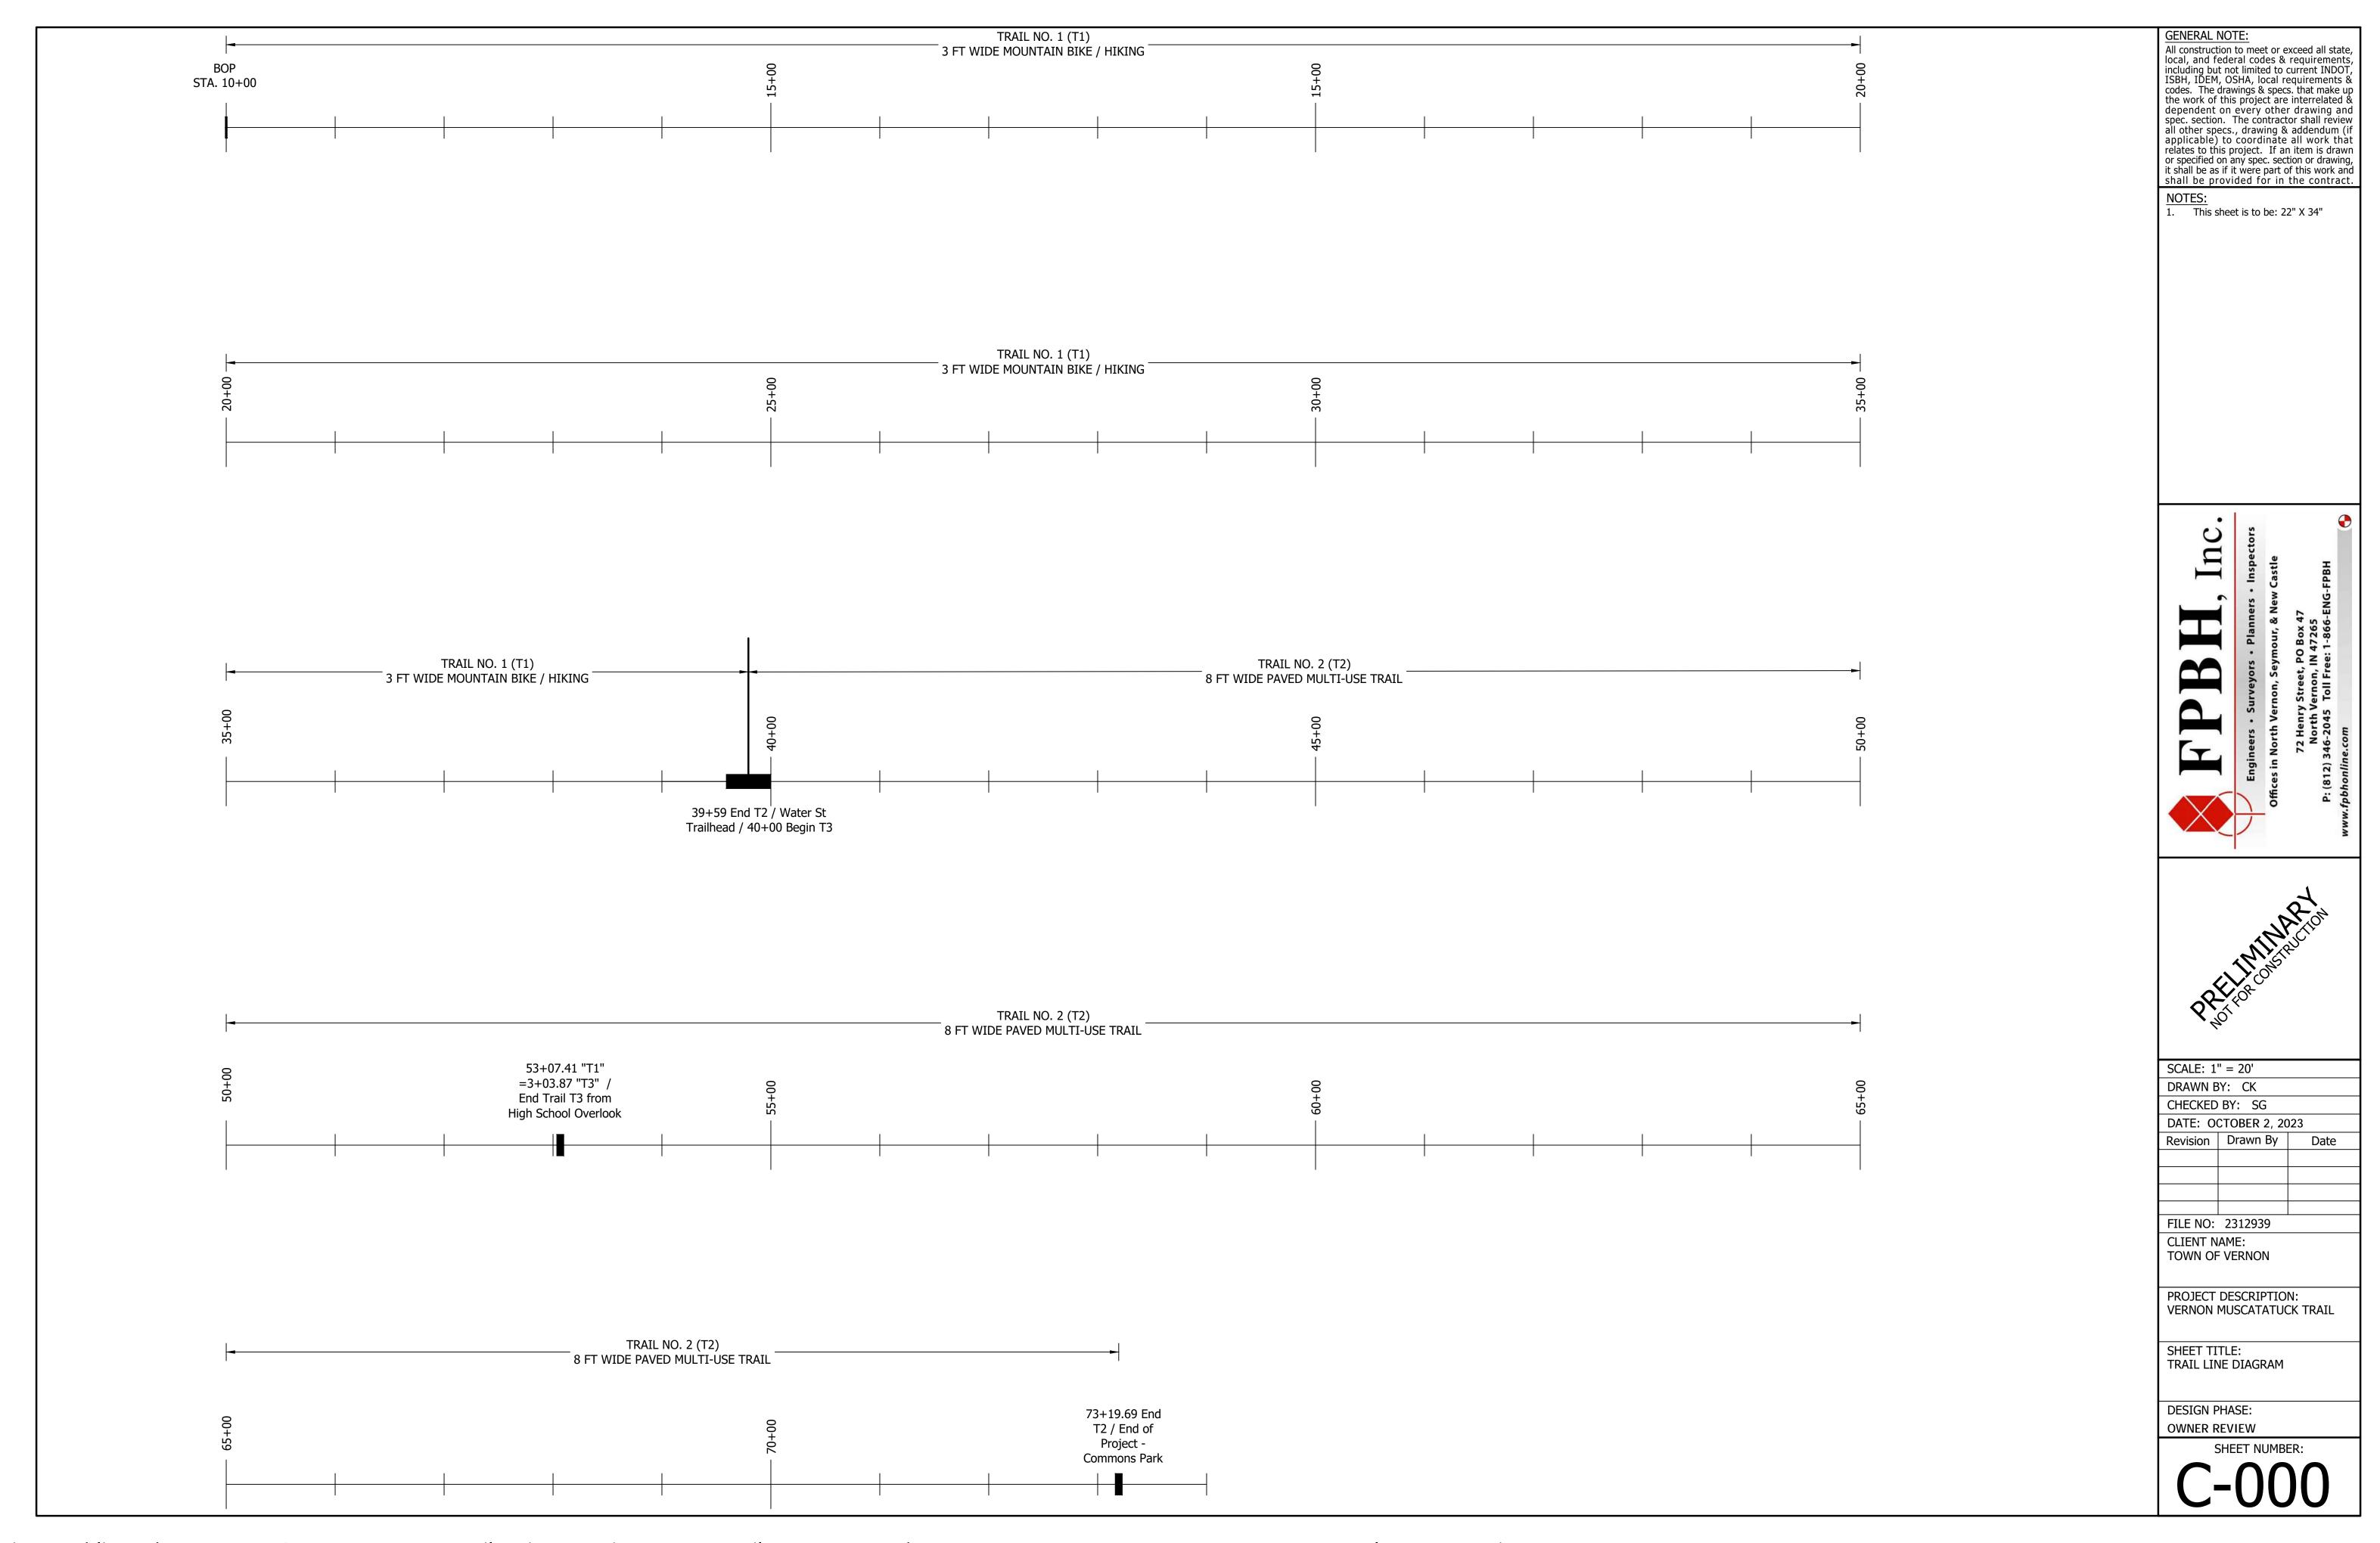

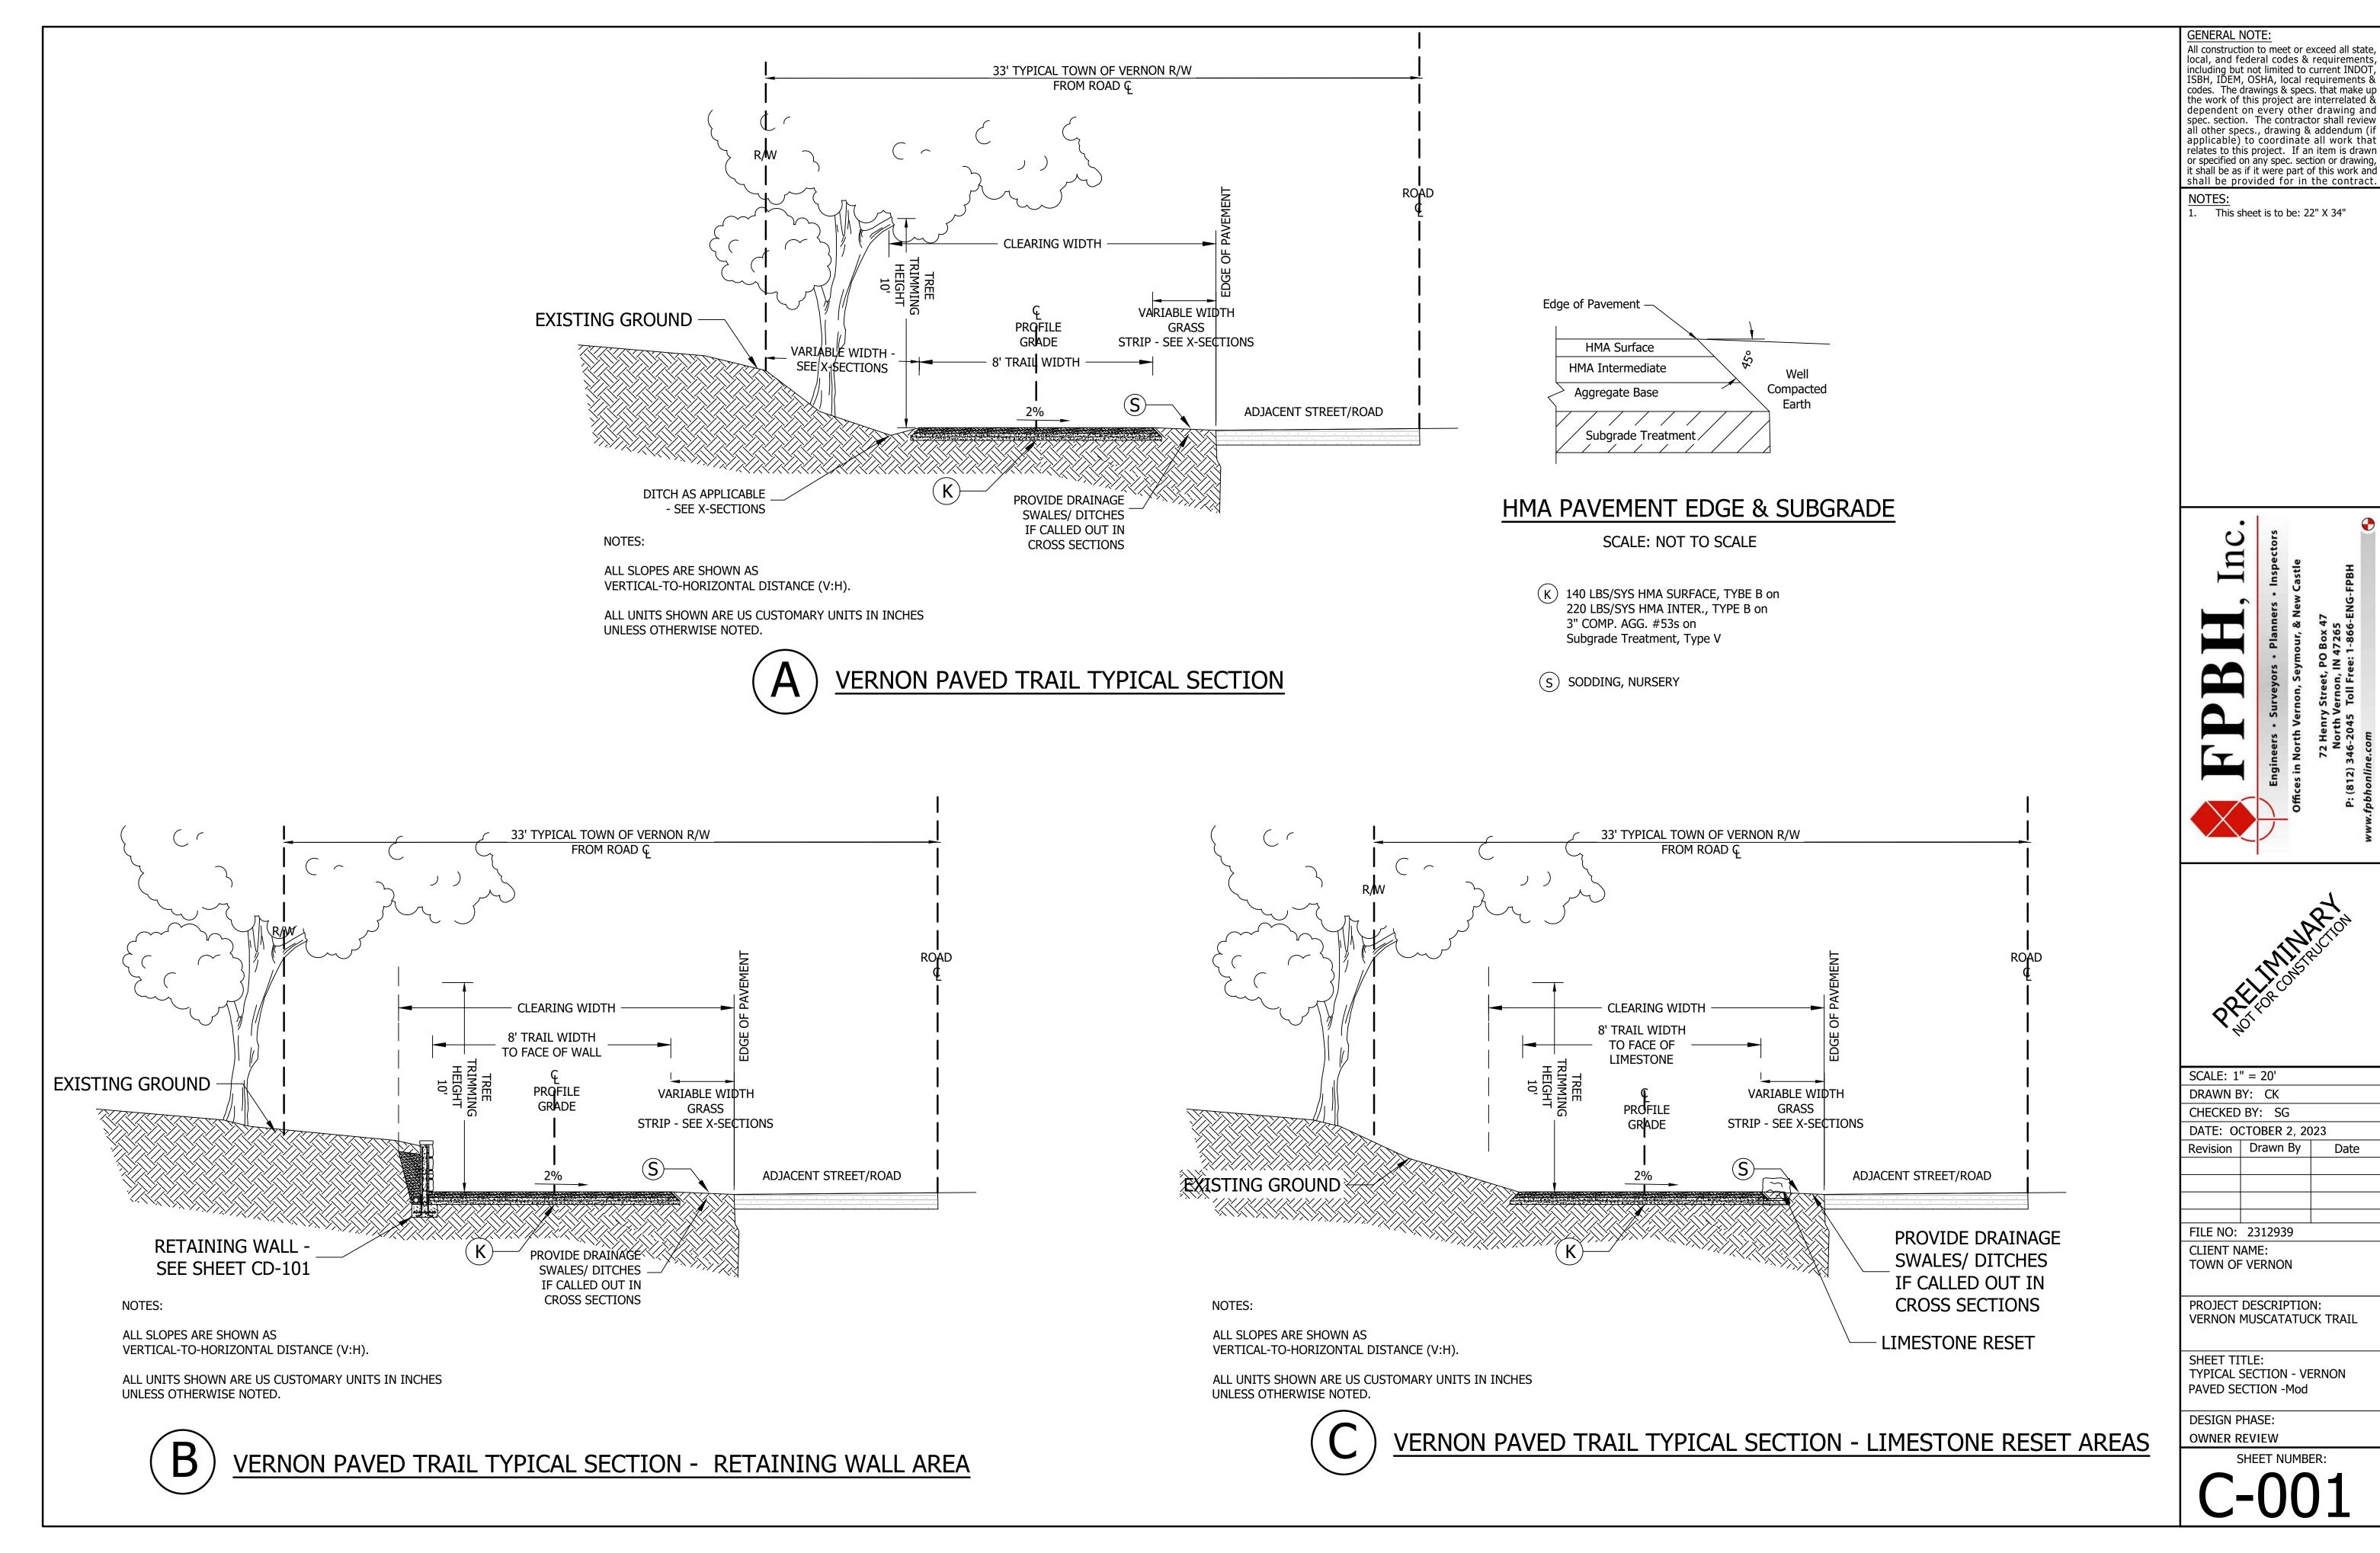

# CLEARING LIMITS - TREES AND LOGS

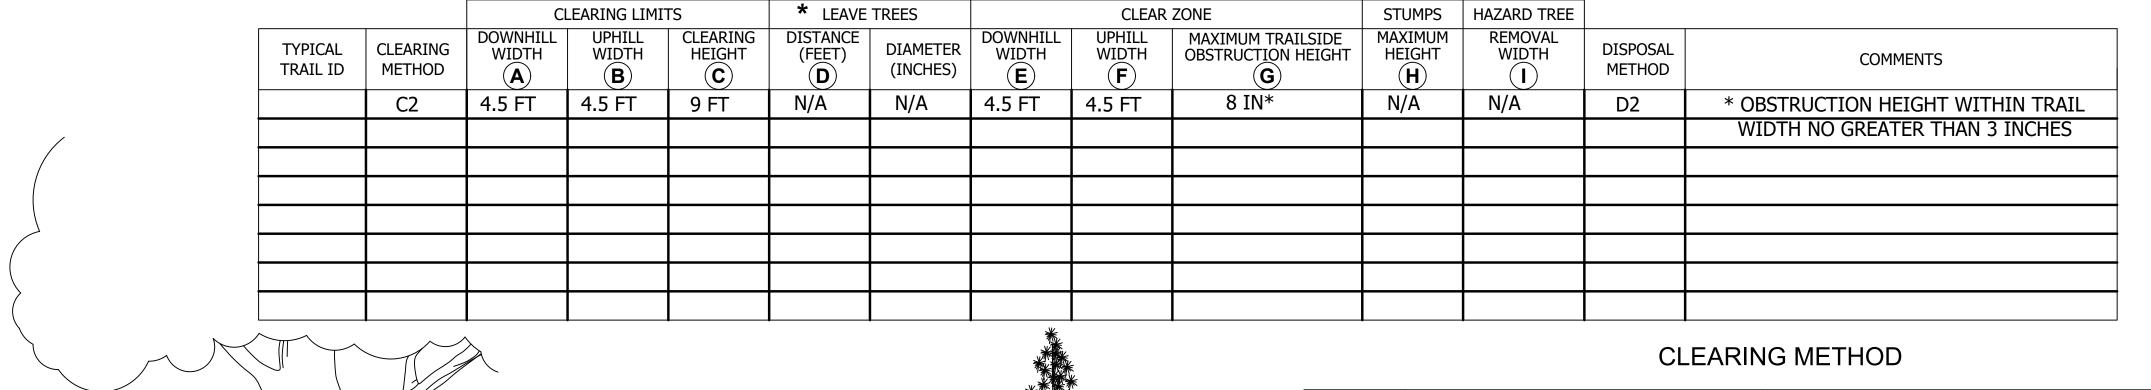

HAZARD TREE REMOVAL

WIDTH

\* LEAVE TREES

DISTANCE

HEIGHT

**CLEARING LIMIT** 

**UPHILL** 

UPHILL

**EMBEDDED** 

ROCK, NO PROTUSION GREATER THAN 3 INCHES

- CLEAR ZONE ----

CLEARING TYPE	CLEARING METHOD	COMMENTS
C1	NEW CONSTRUCTION	TREES, PRUNING, & BRUSH
C2	CLEARING LIMIT RESTORATION	TREES, PRUNING, LOGS, BRUSH & MAINTENANCE
C3	TRAIL OPENING	LOGGING OUT, LOOSE ROCK & DRAINAGE CLEARING
C4	HAZARD TREE REMOVAL	ALONG TRAIL CORRIDOR
C5	HAZARD TREE REMOVAL	INDIVIDUAL (AS MARKED)
C6	LOOSE ROCK & ROOT REMOVAL	
C7		

LEAVE TREES:

LEAVE TREES SHOULD BE LIVE, SOUND & UNDAMAGED WITH UNCOMPROMISED ROOT SYSTEMS.

HAZARD TREES:

HAZARD TREES ARE TREES THAT ARE STANDING OR LEANING DEAD TREES LARGER THAN 8 INCHES IN DIAMETER AND GREATER THAN 90 FEET IN HEIGHT

# DISPOSAL METHOD

DISPOSAL TYPE	DISPOSAL METHOD	COMMENTS
D1	LOP AND SCATTER OUTSIDE TRAILWAY	
D2	LOP AND SCATTER ON FILL SLOPE	
D3	PILE AND BURN	
D4	CHIP	
D5	HAUL TO DISPOSAL SITE	
D6		



LEAVE TREES DISTANCE

| MAXIMUM OBSTRUCTION

> LOOSE ROCK, REMOVE

RIVER HIKING & MOUNTAIN BIKE TYPICAL SECTION

HAZARD TREE

REMOVAL

**CLEARING LIMIT** 

DOWNHILL

DOWNHILL CLEAR ZONE

**CLEARING** 

3' WIDE TRAIL

GENERAL NOTE:

All construction to meet or exceed all state, local, and federal codes & requirements, including but not limited to current INDOT, ISBH, IDEM, OSHA, local requirements & codes. The drawings & specs. that make up the work of this project are interrelated & dependent on every other drawing and spec. section. The contractor shall review all other specs., drawing & addendum (if applicable) to coordinate all work that relates to this project. If an item is drawn or specified on any spec. section or drawing, it shall be as if it were part of this work and shall be provided for in the contract.

1. This sheet is to be: 22" X 34"

Engineers · Surveyors · Planners · Inspectors

Offices in North Vernon, Seymour, & New Castle

72 Henry Street, PO Box 47

North Vernon, IN 47265

P: (812) 346-2045 Toll Free: 1-866-ENG-FPBH



	DRAWN BY: CK CHECKED BY: SG									
	DATE: O	CTOBER 2, 20	)23							
	Revision	Drawn By	Date							

FILE NO: 2312939


CLIENT NAME:
TOWN OF VERNON


PROJECT DESCRIPTION: VERNON MUSCATATUCK TRAIL


SHEET TITLE:
TYPICAL SECTION - RIVER
HIKING & MOUNTAIN BIKE
SECTION
DESIGN PHASE:
OWNER REVIEW


SHEET NUMBER:


C-002

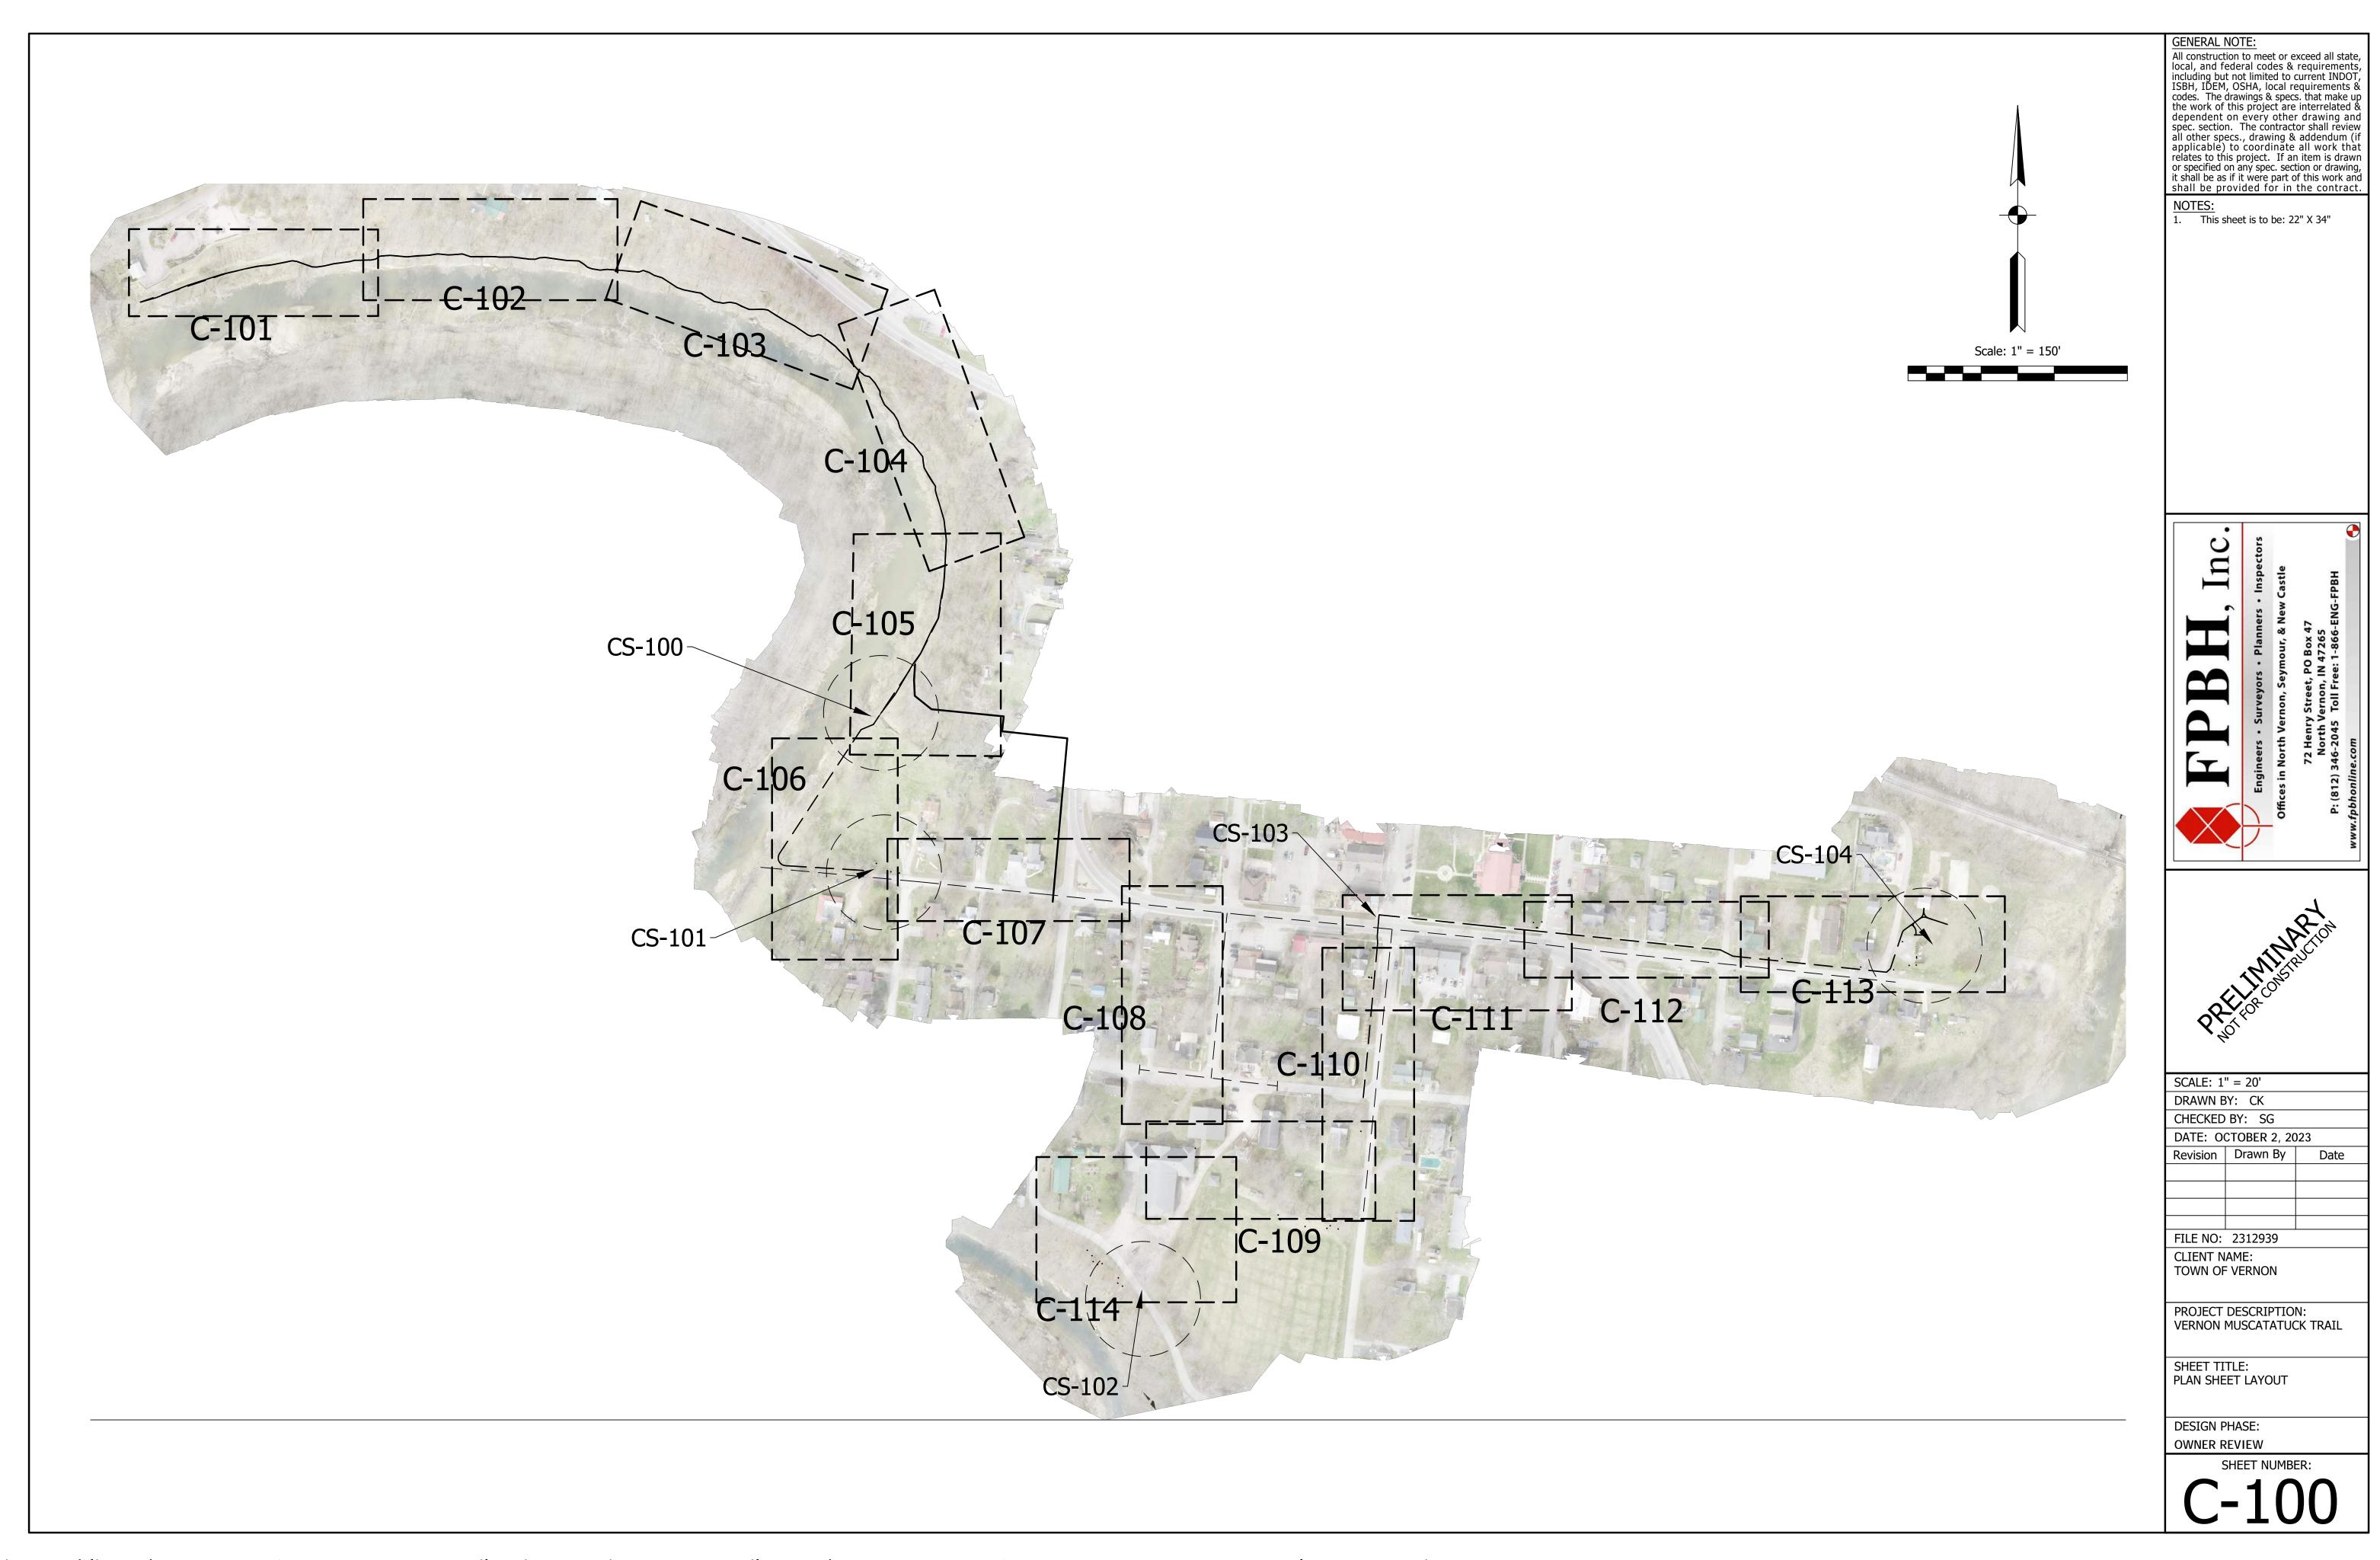


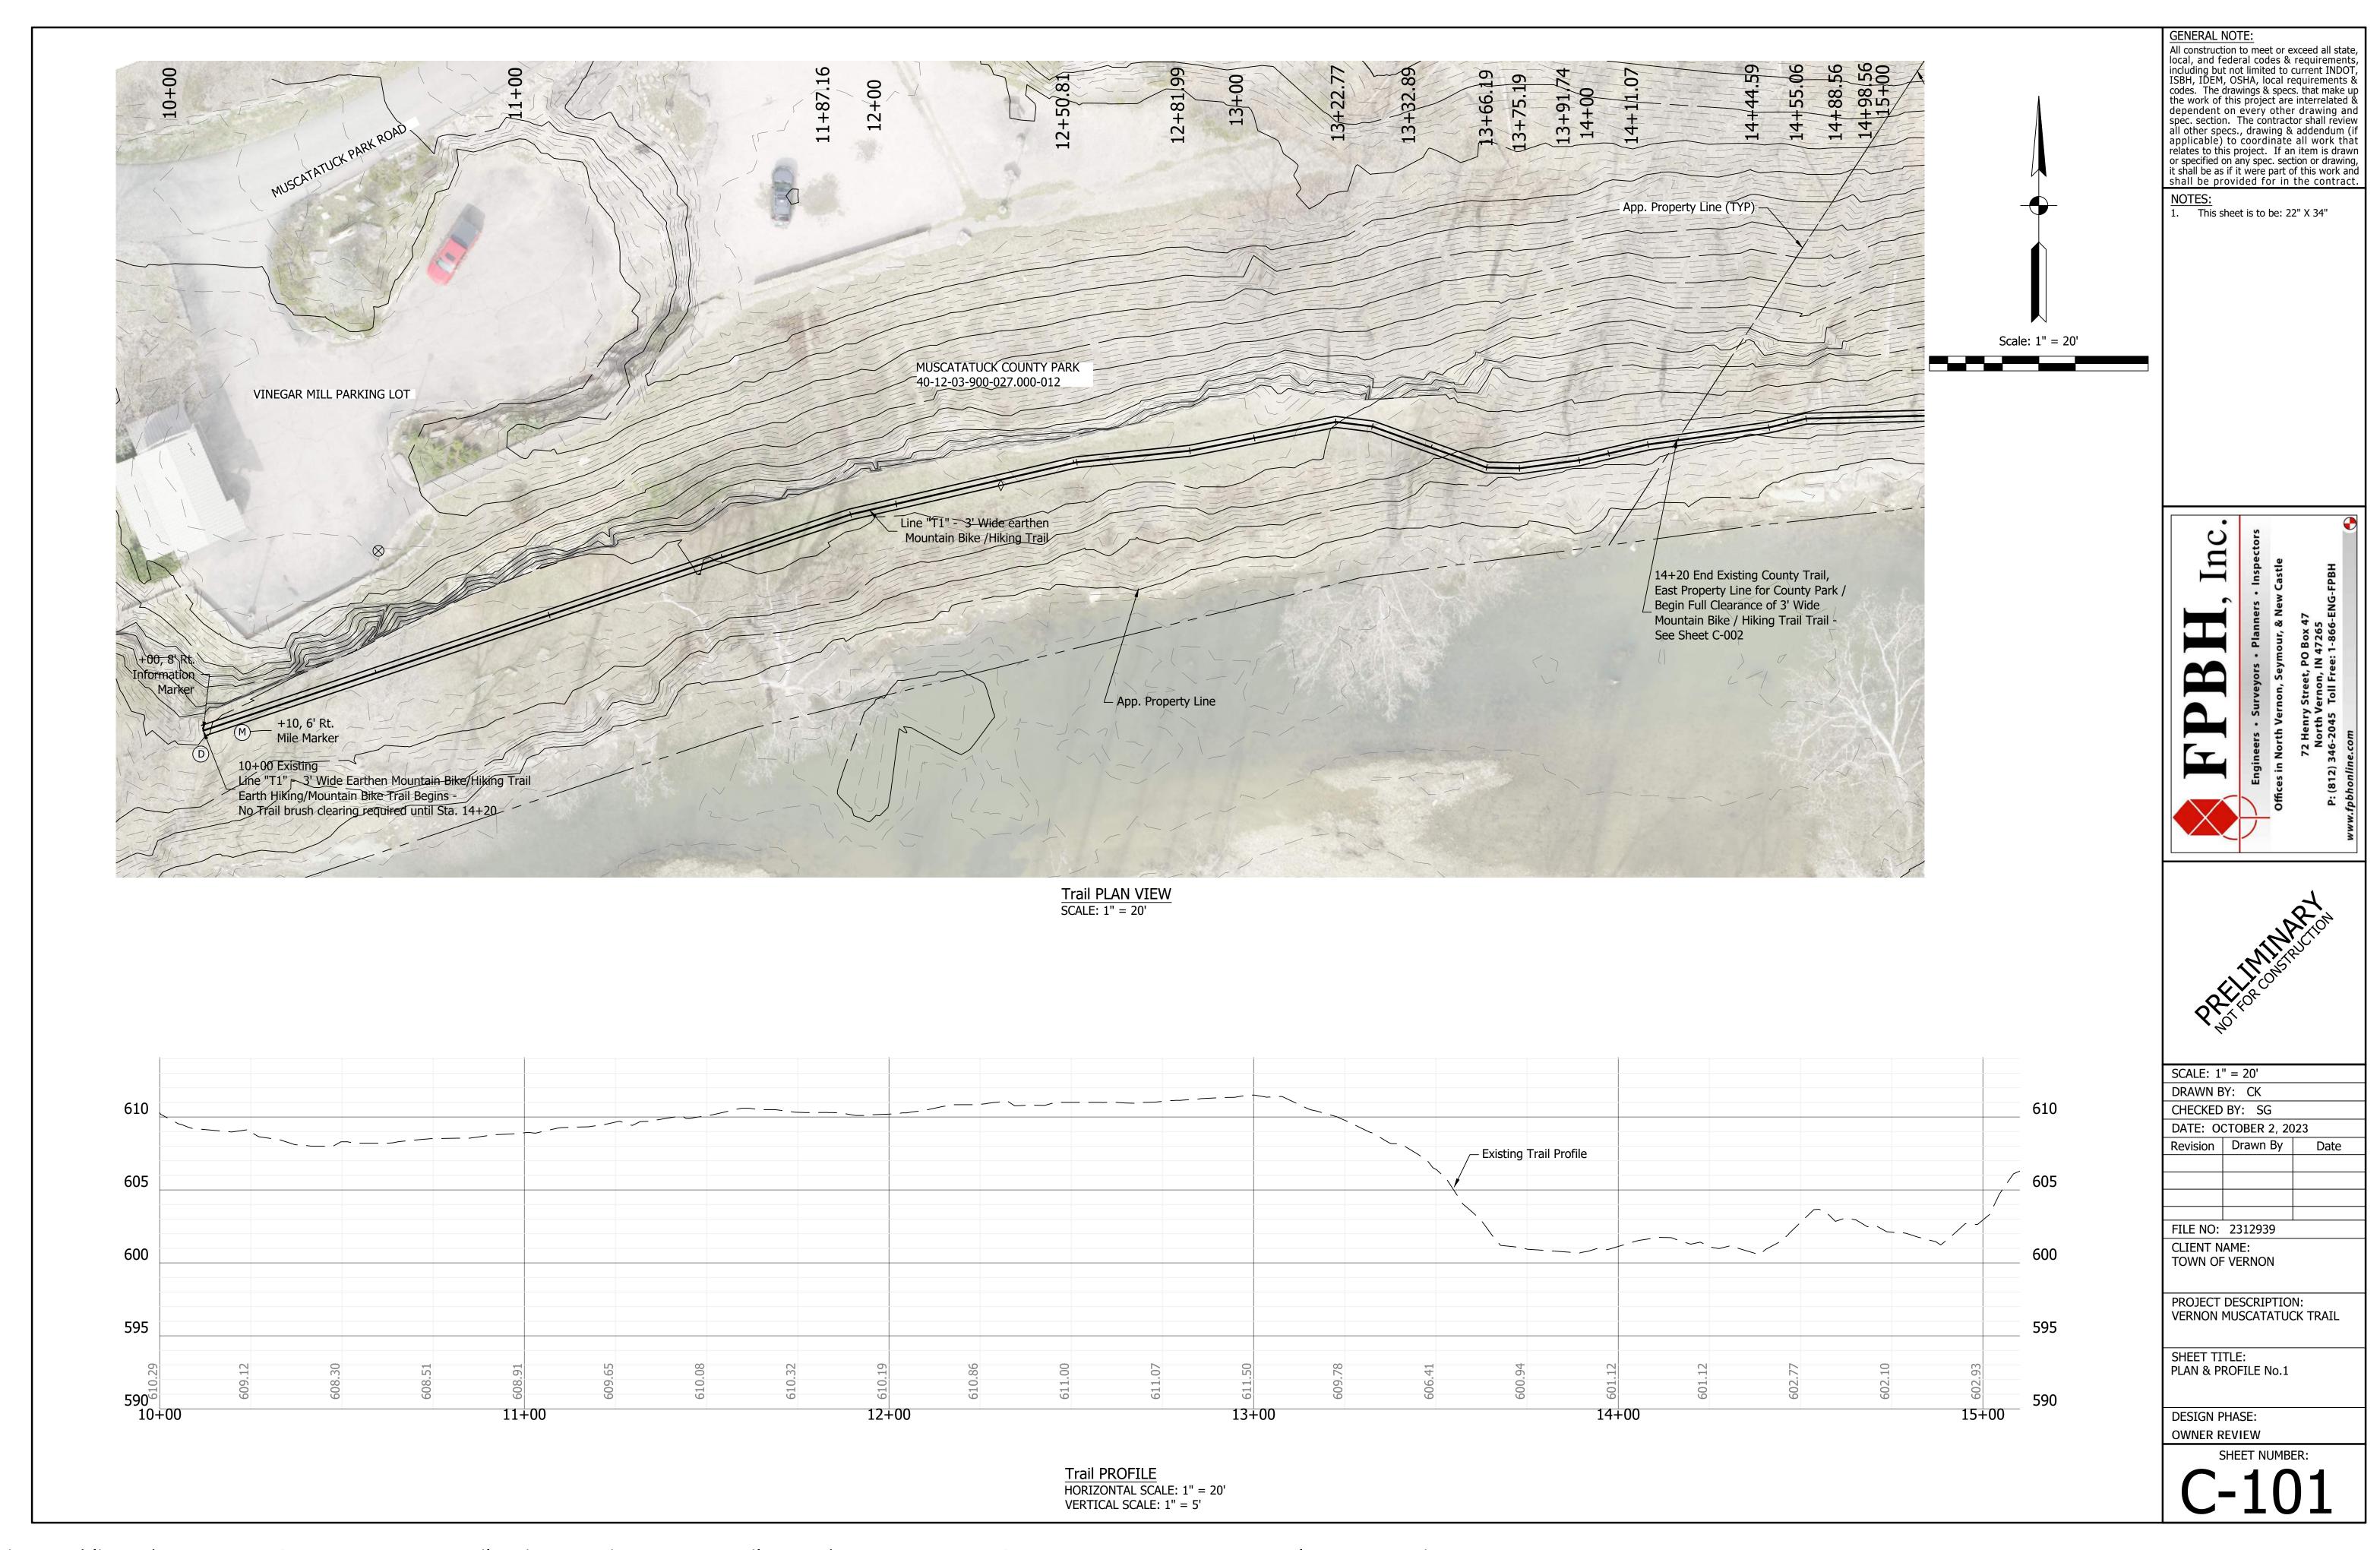


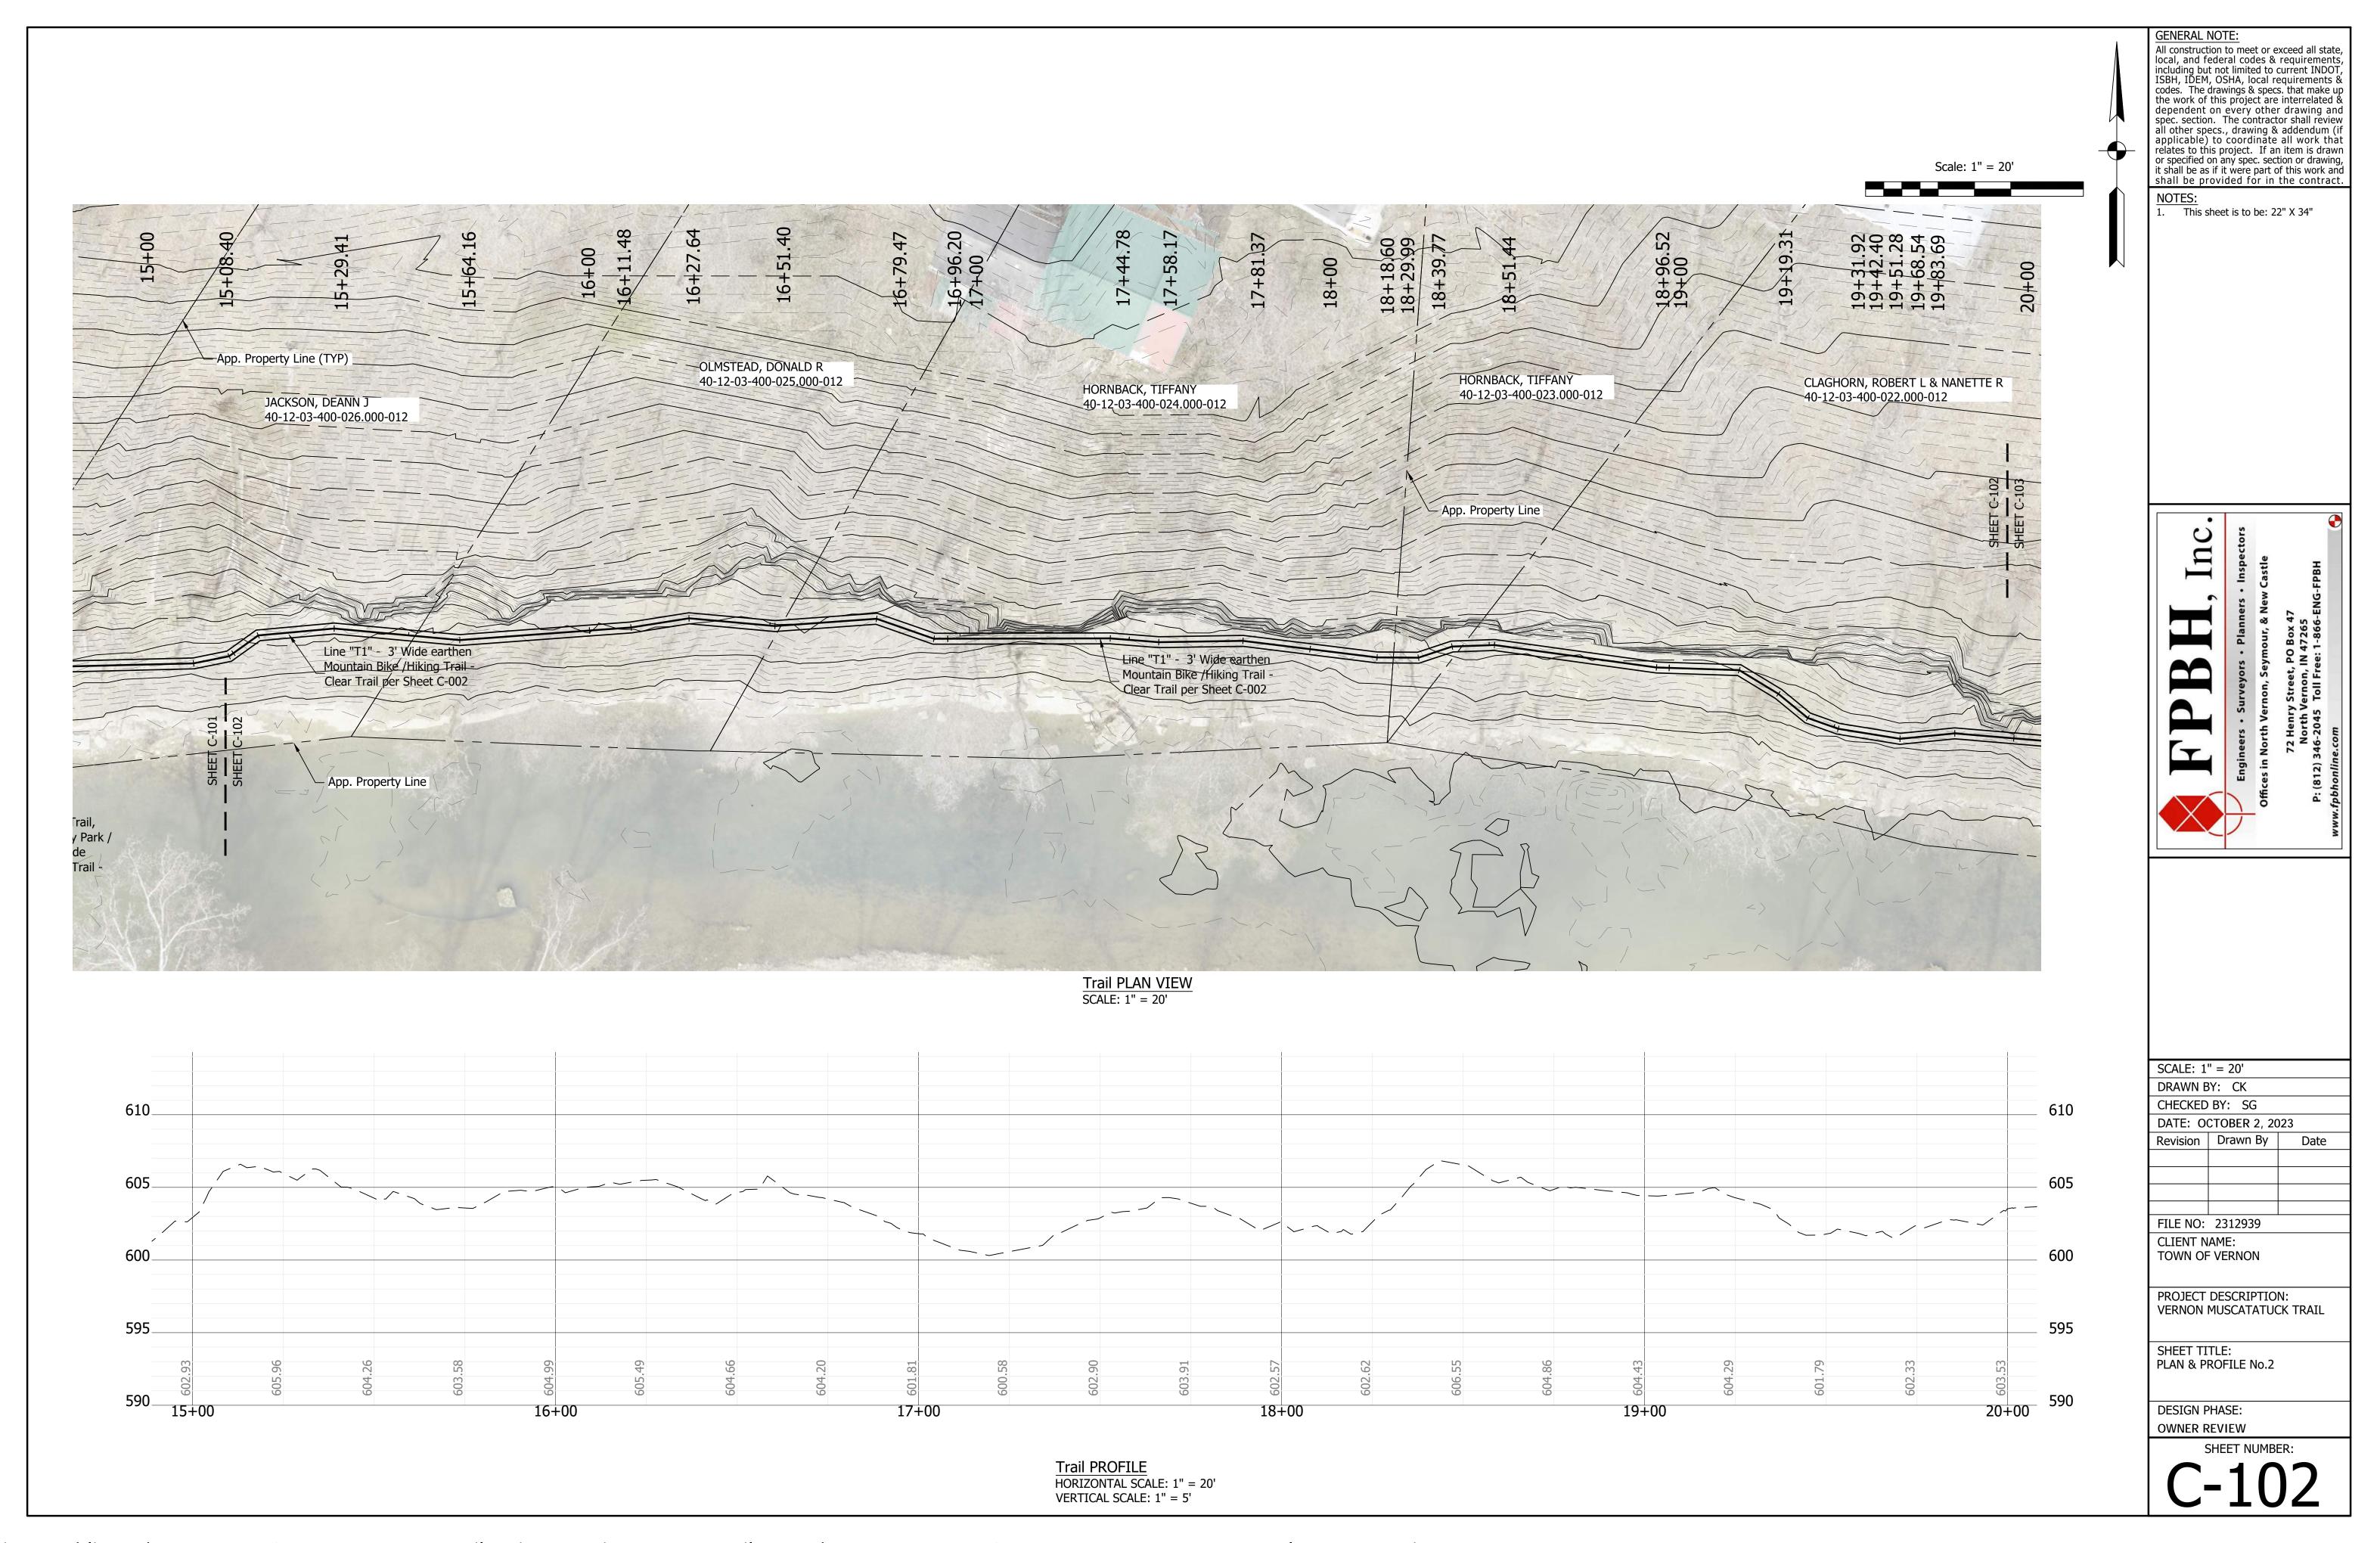


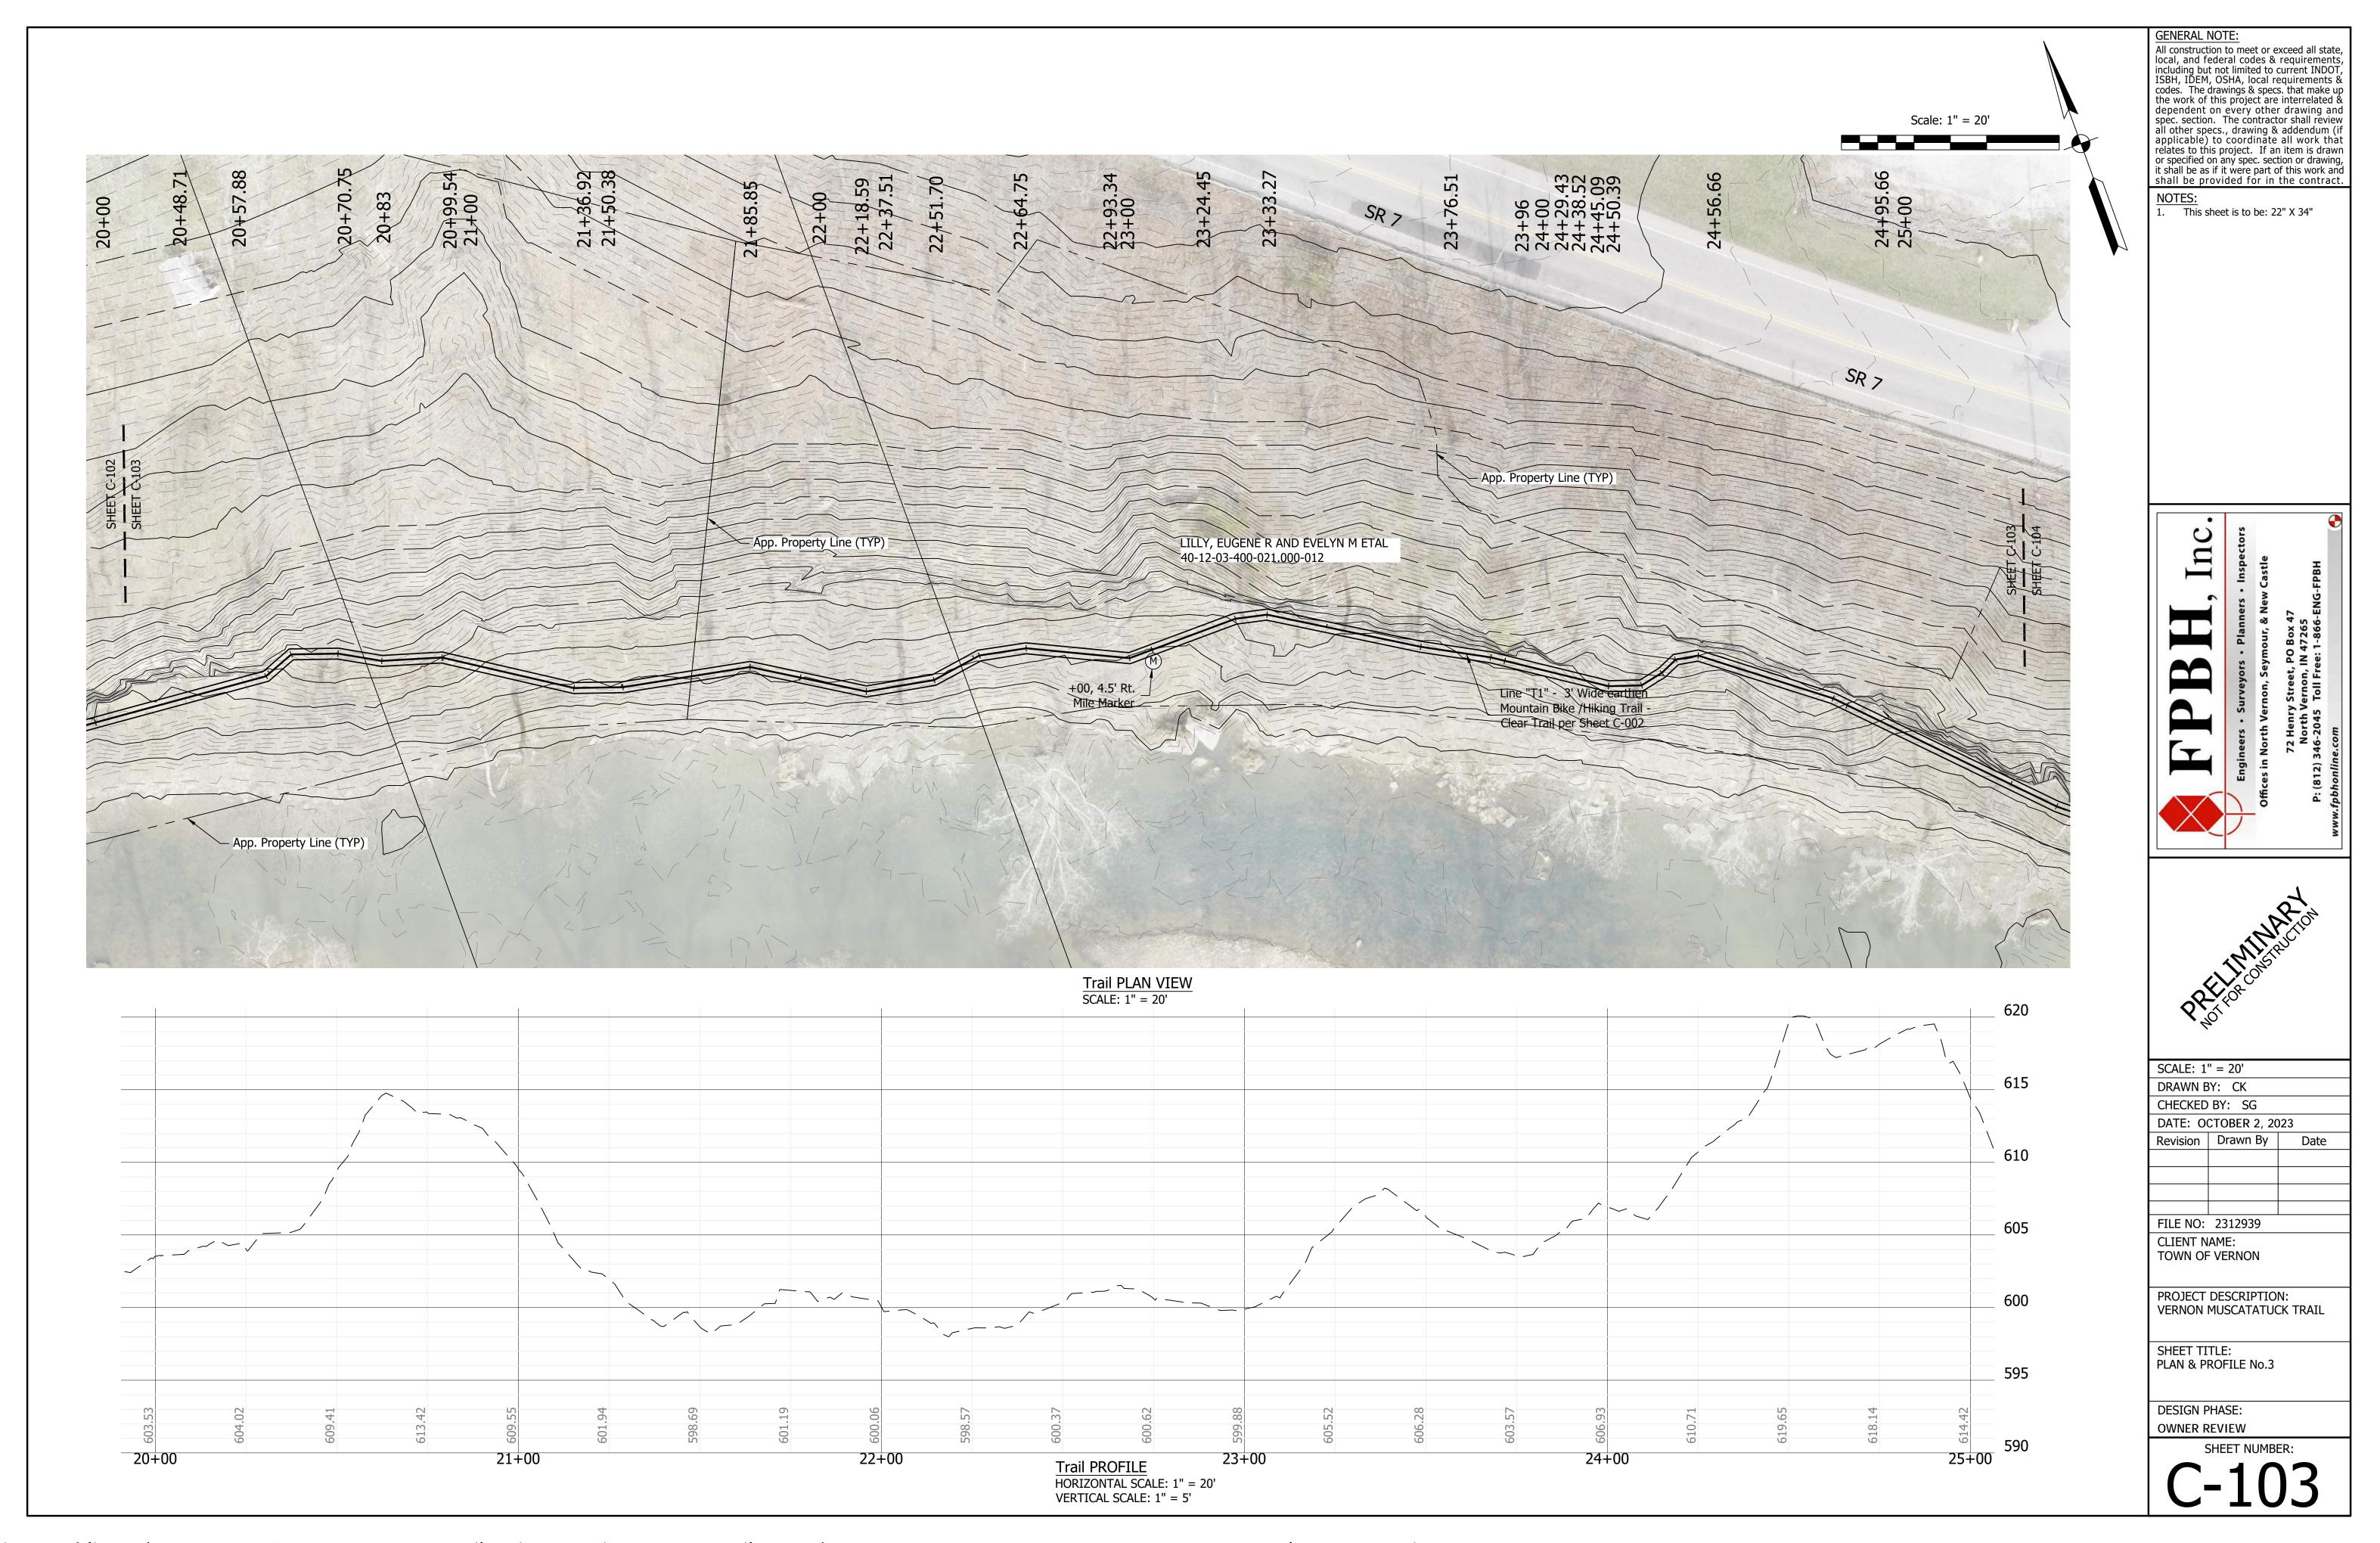


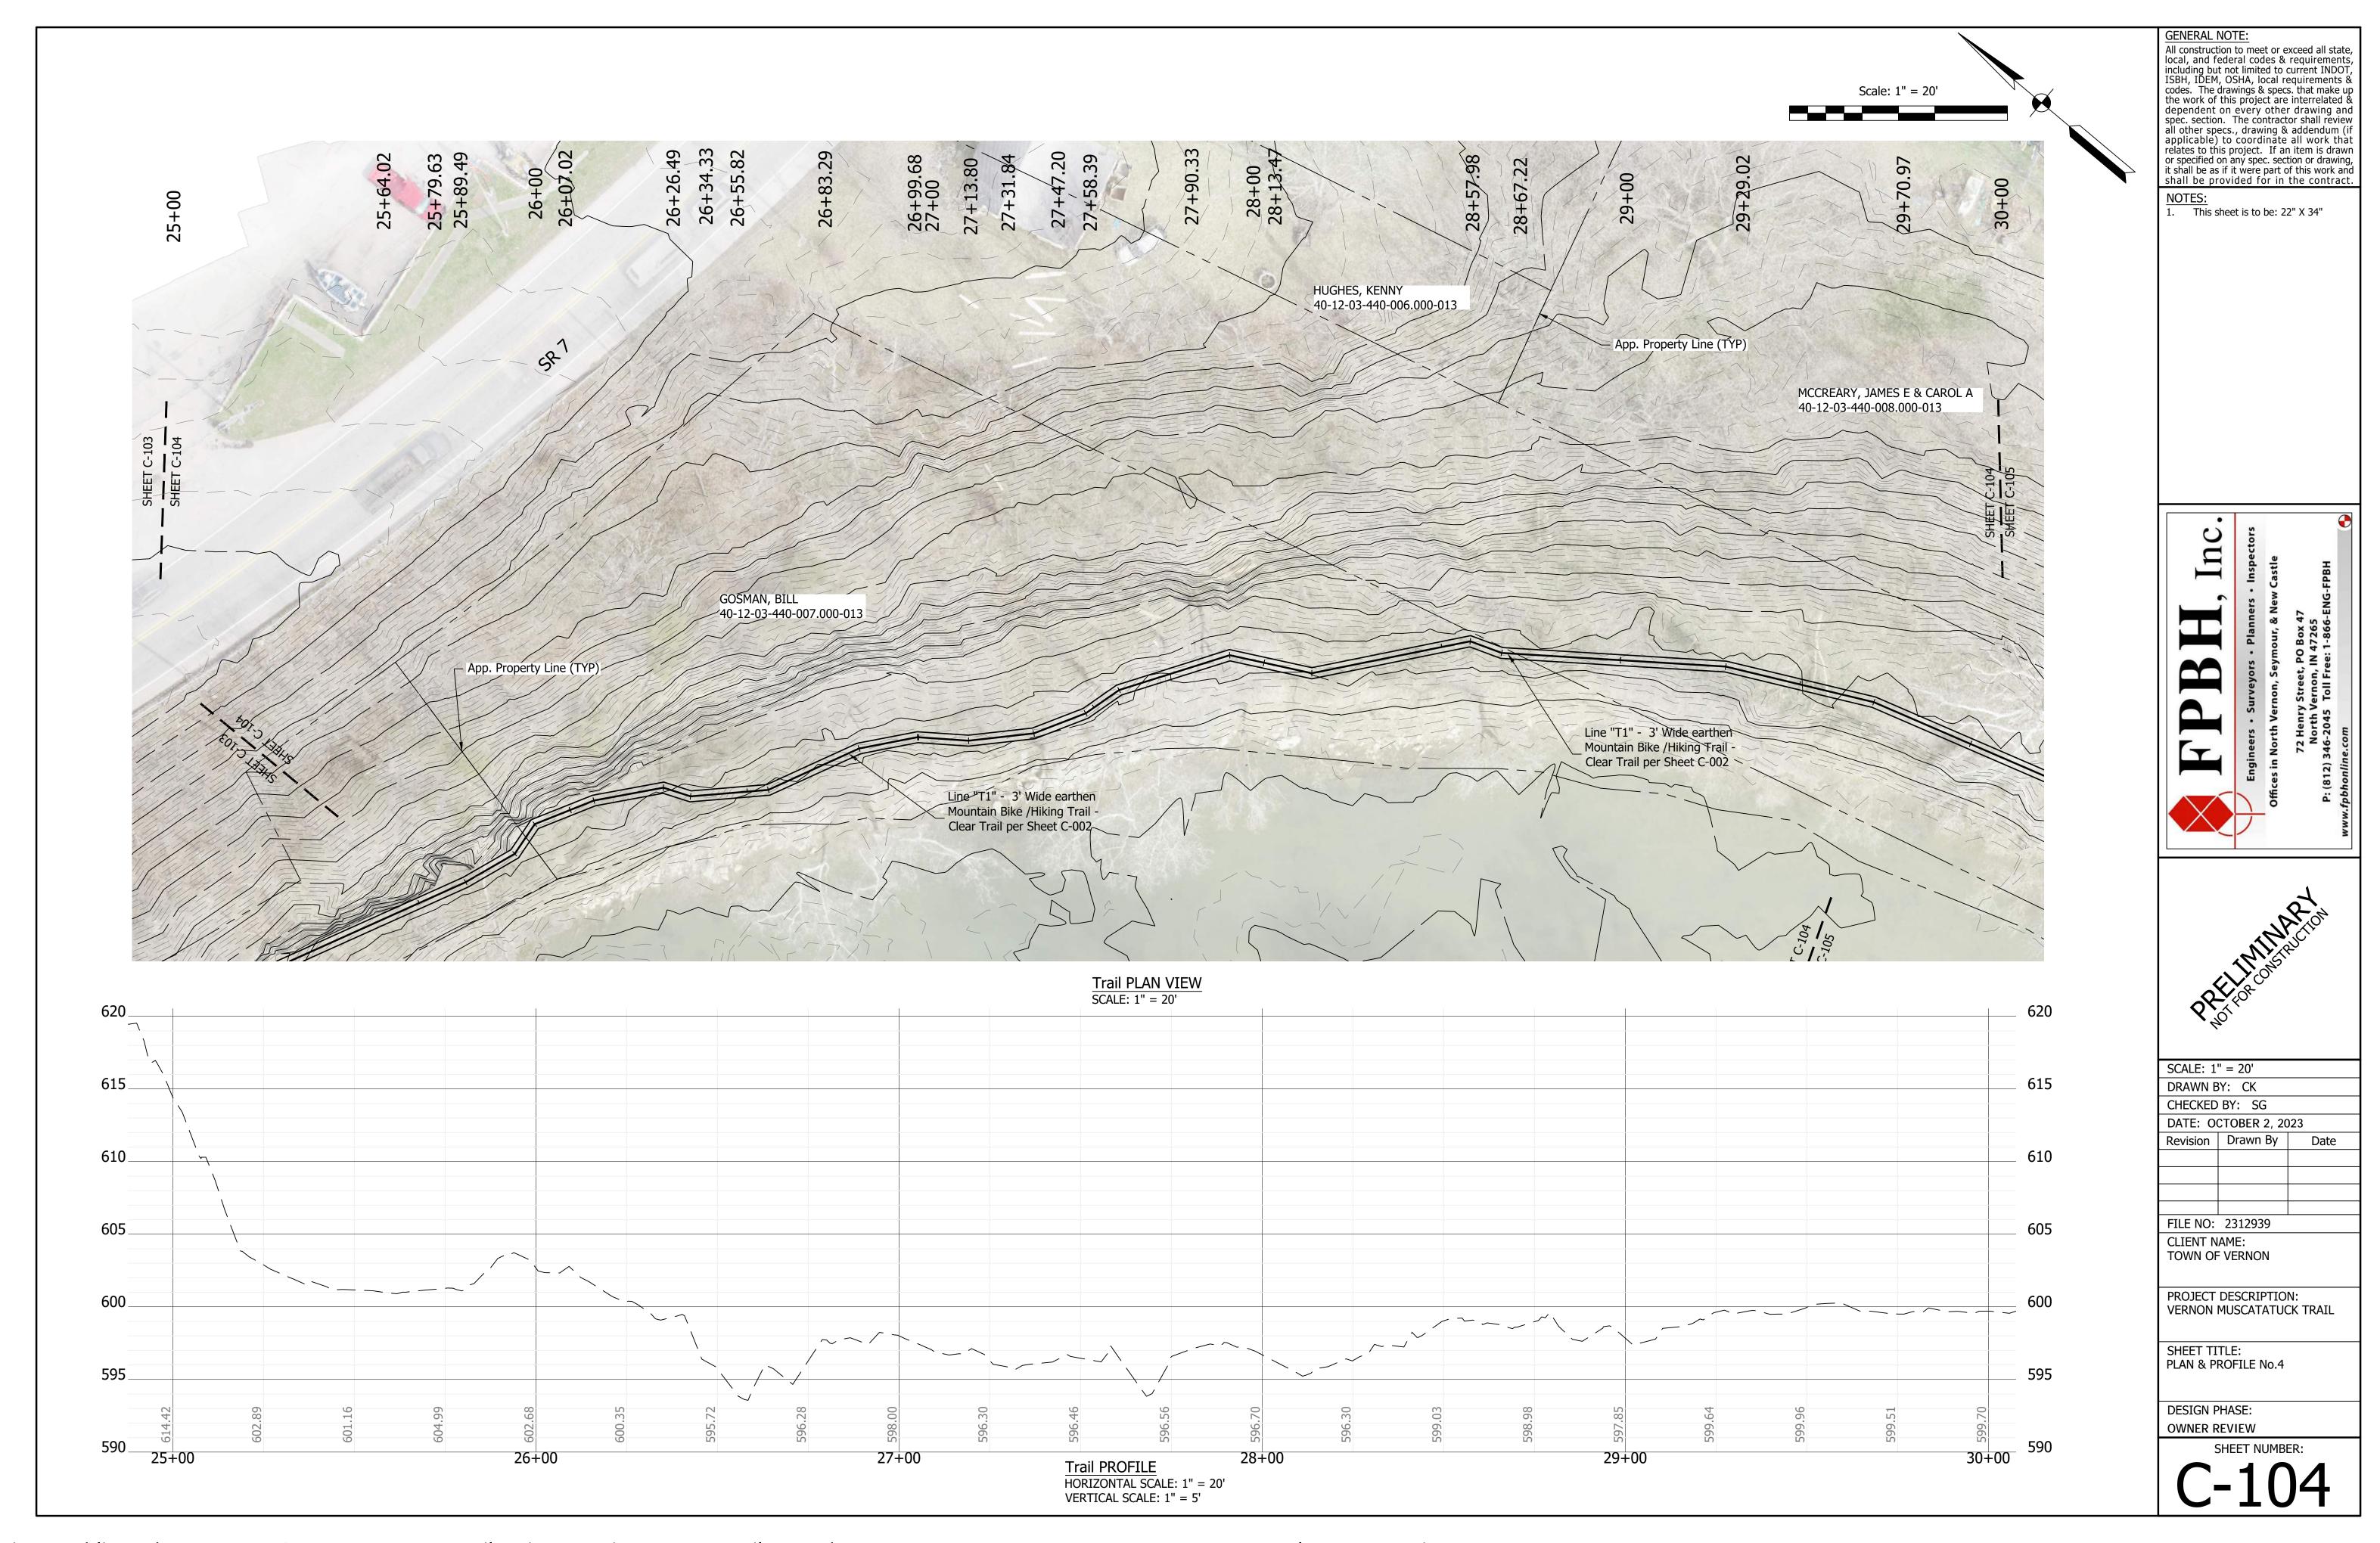


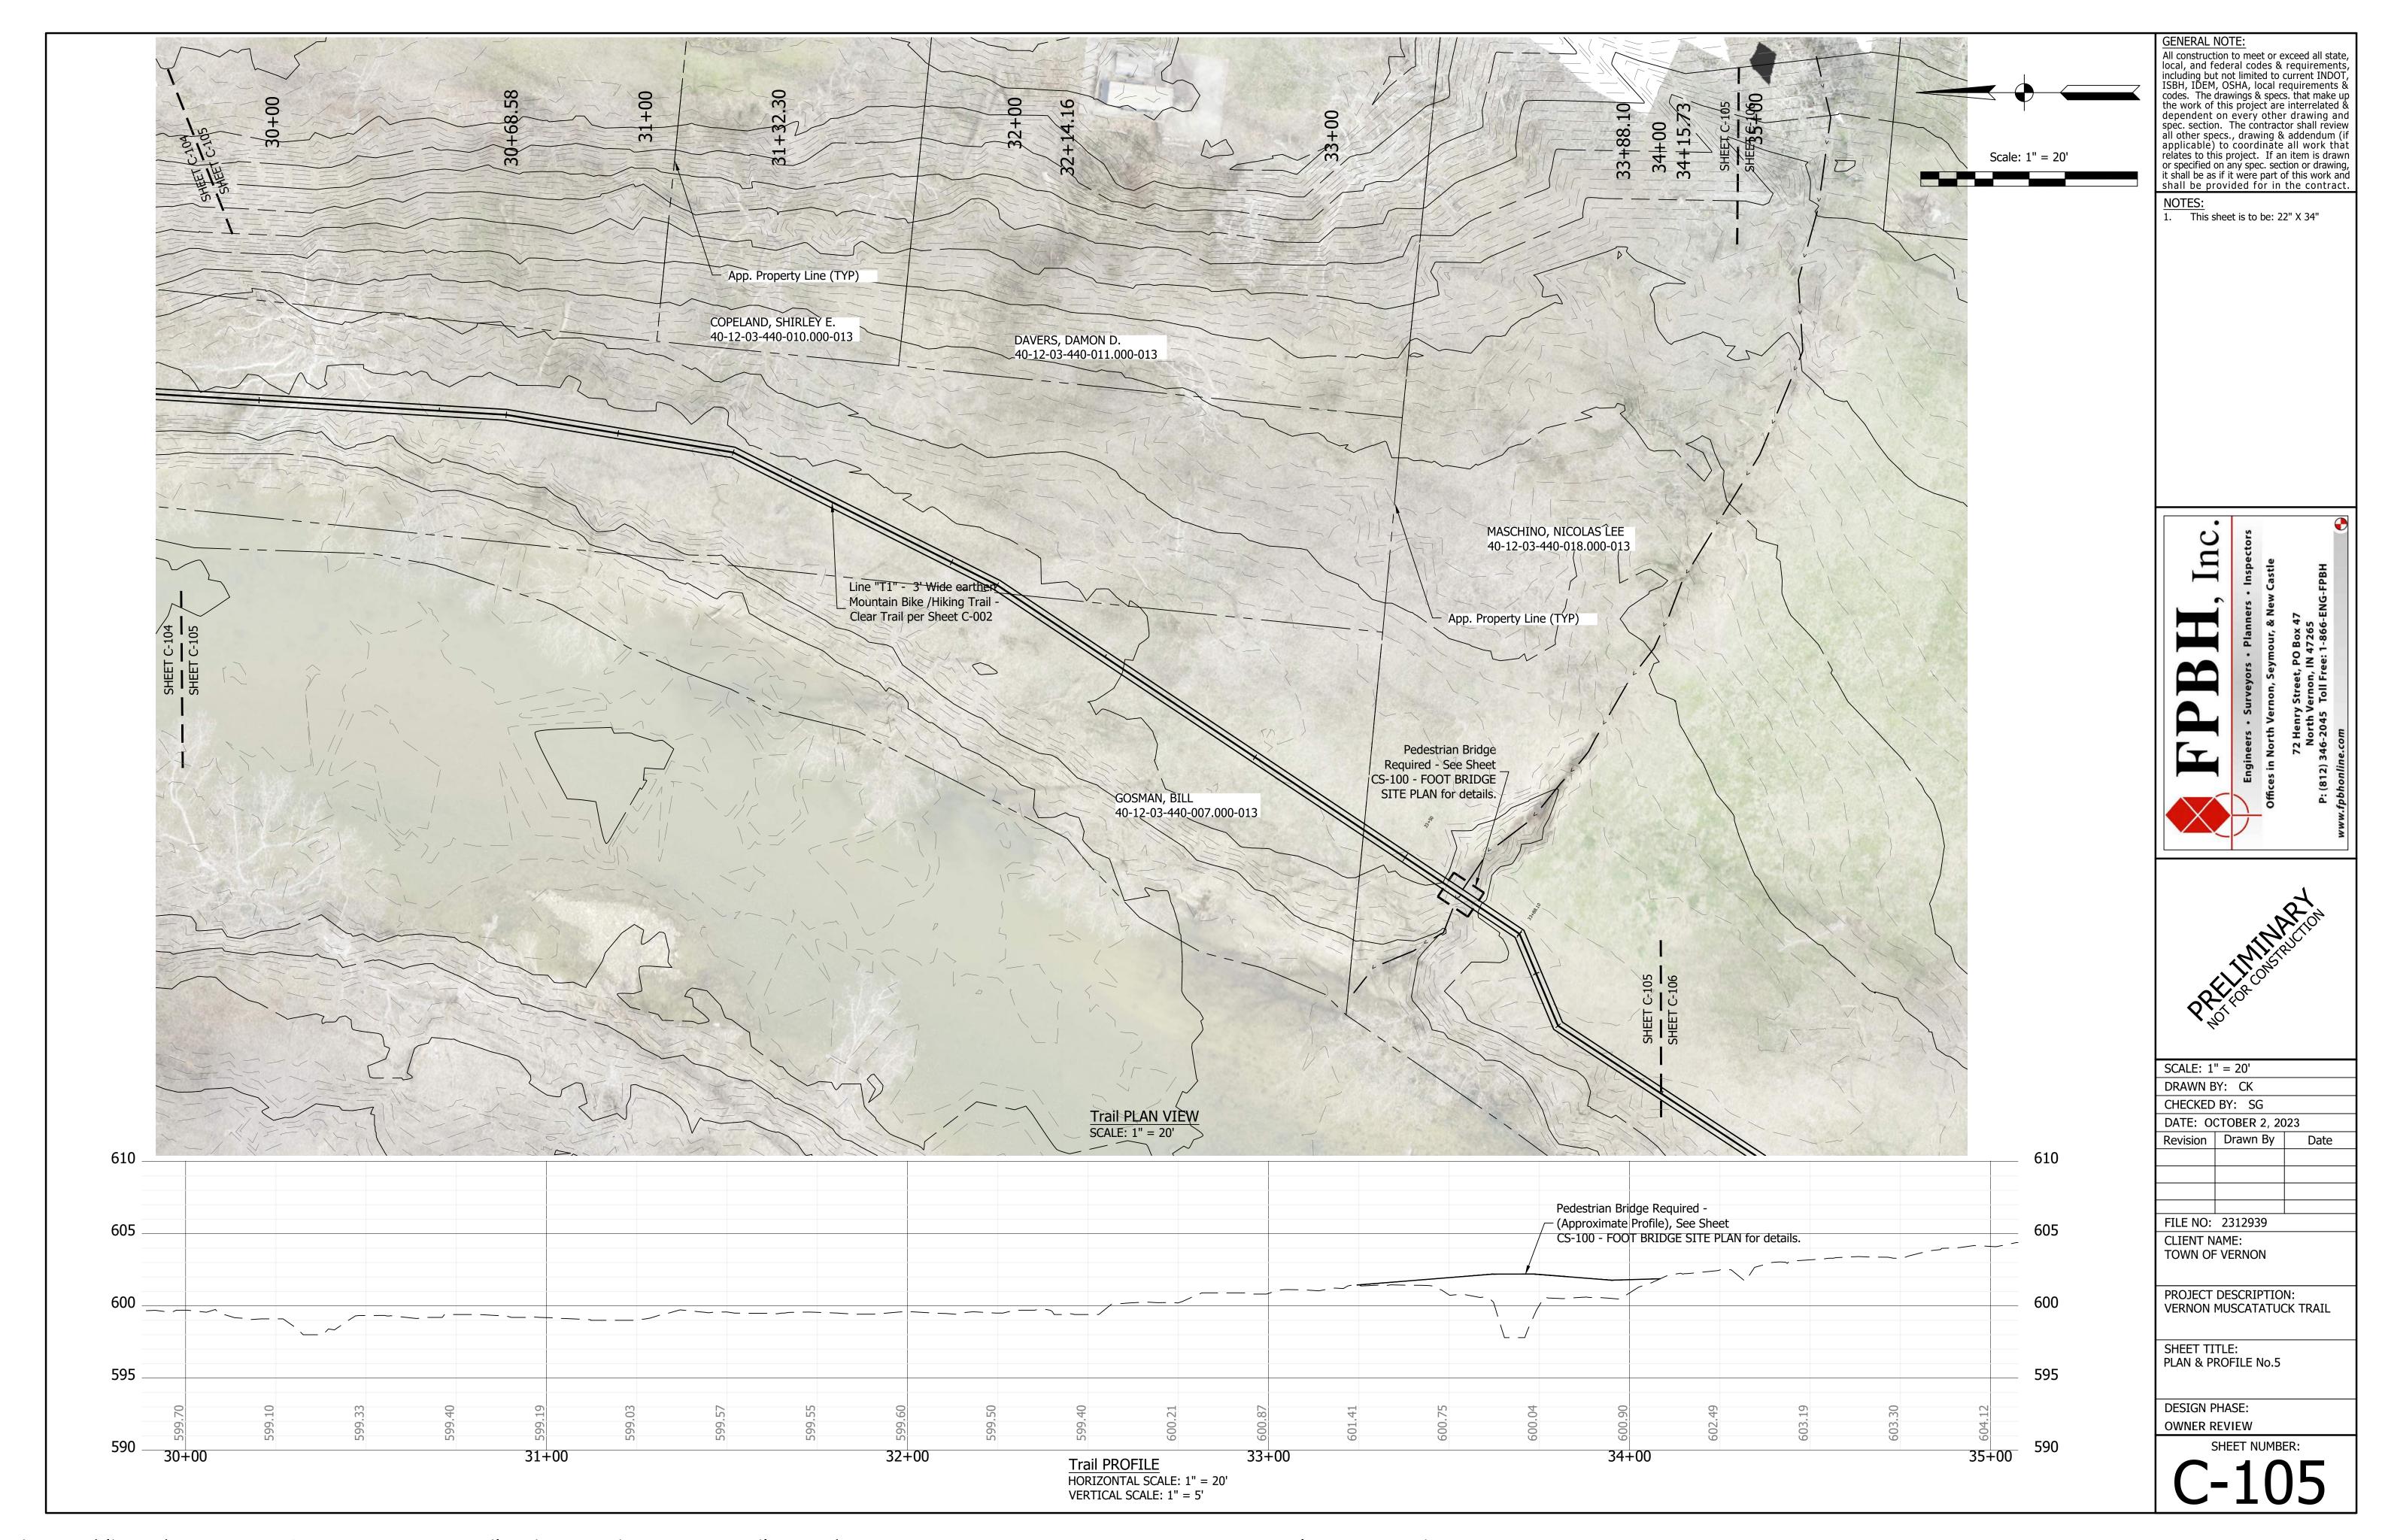

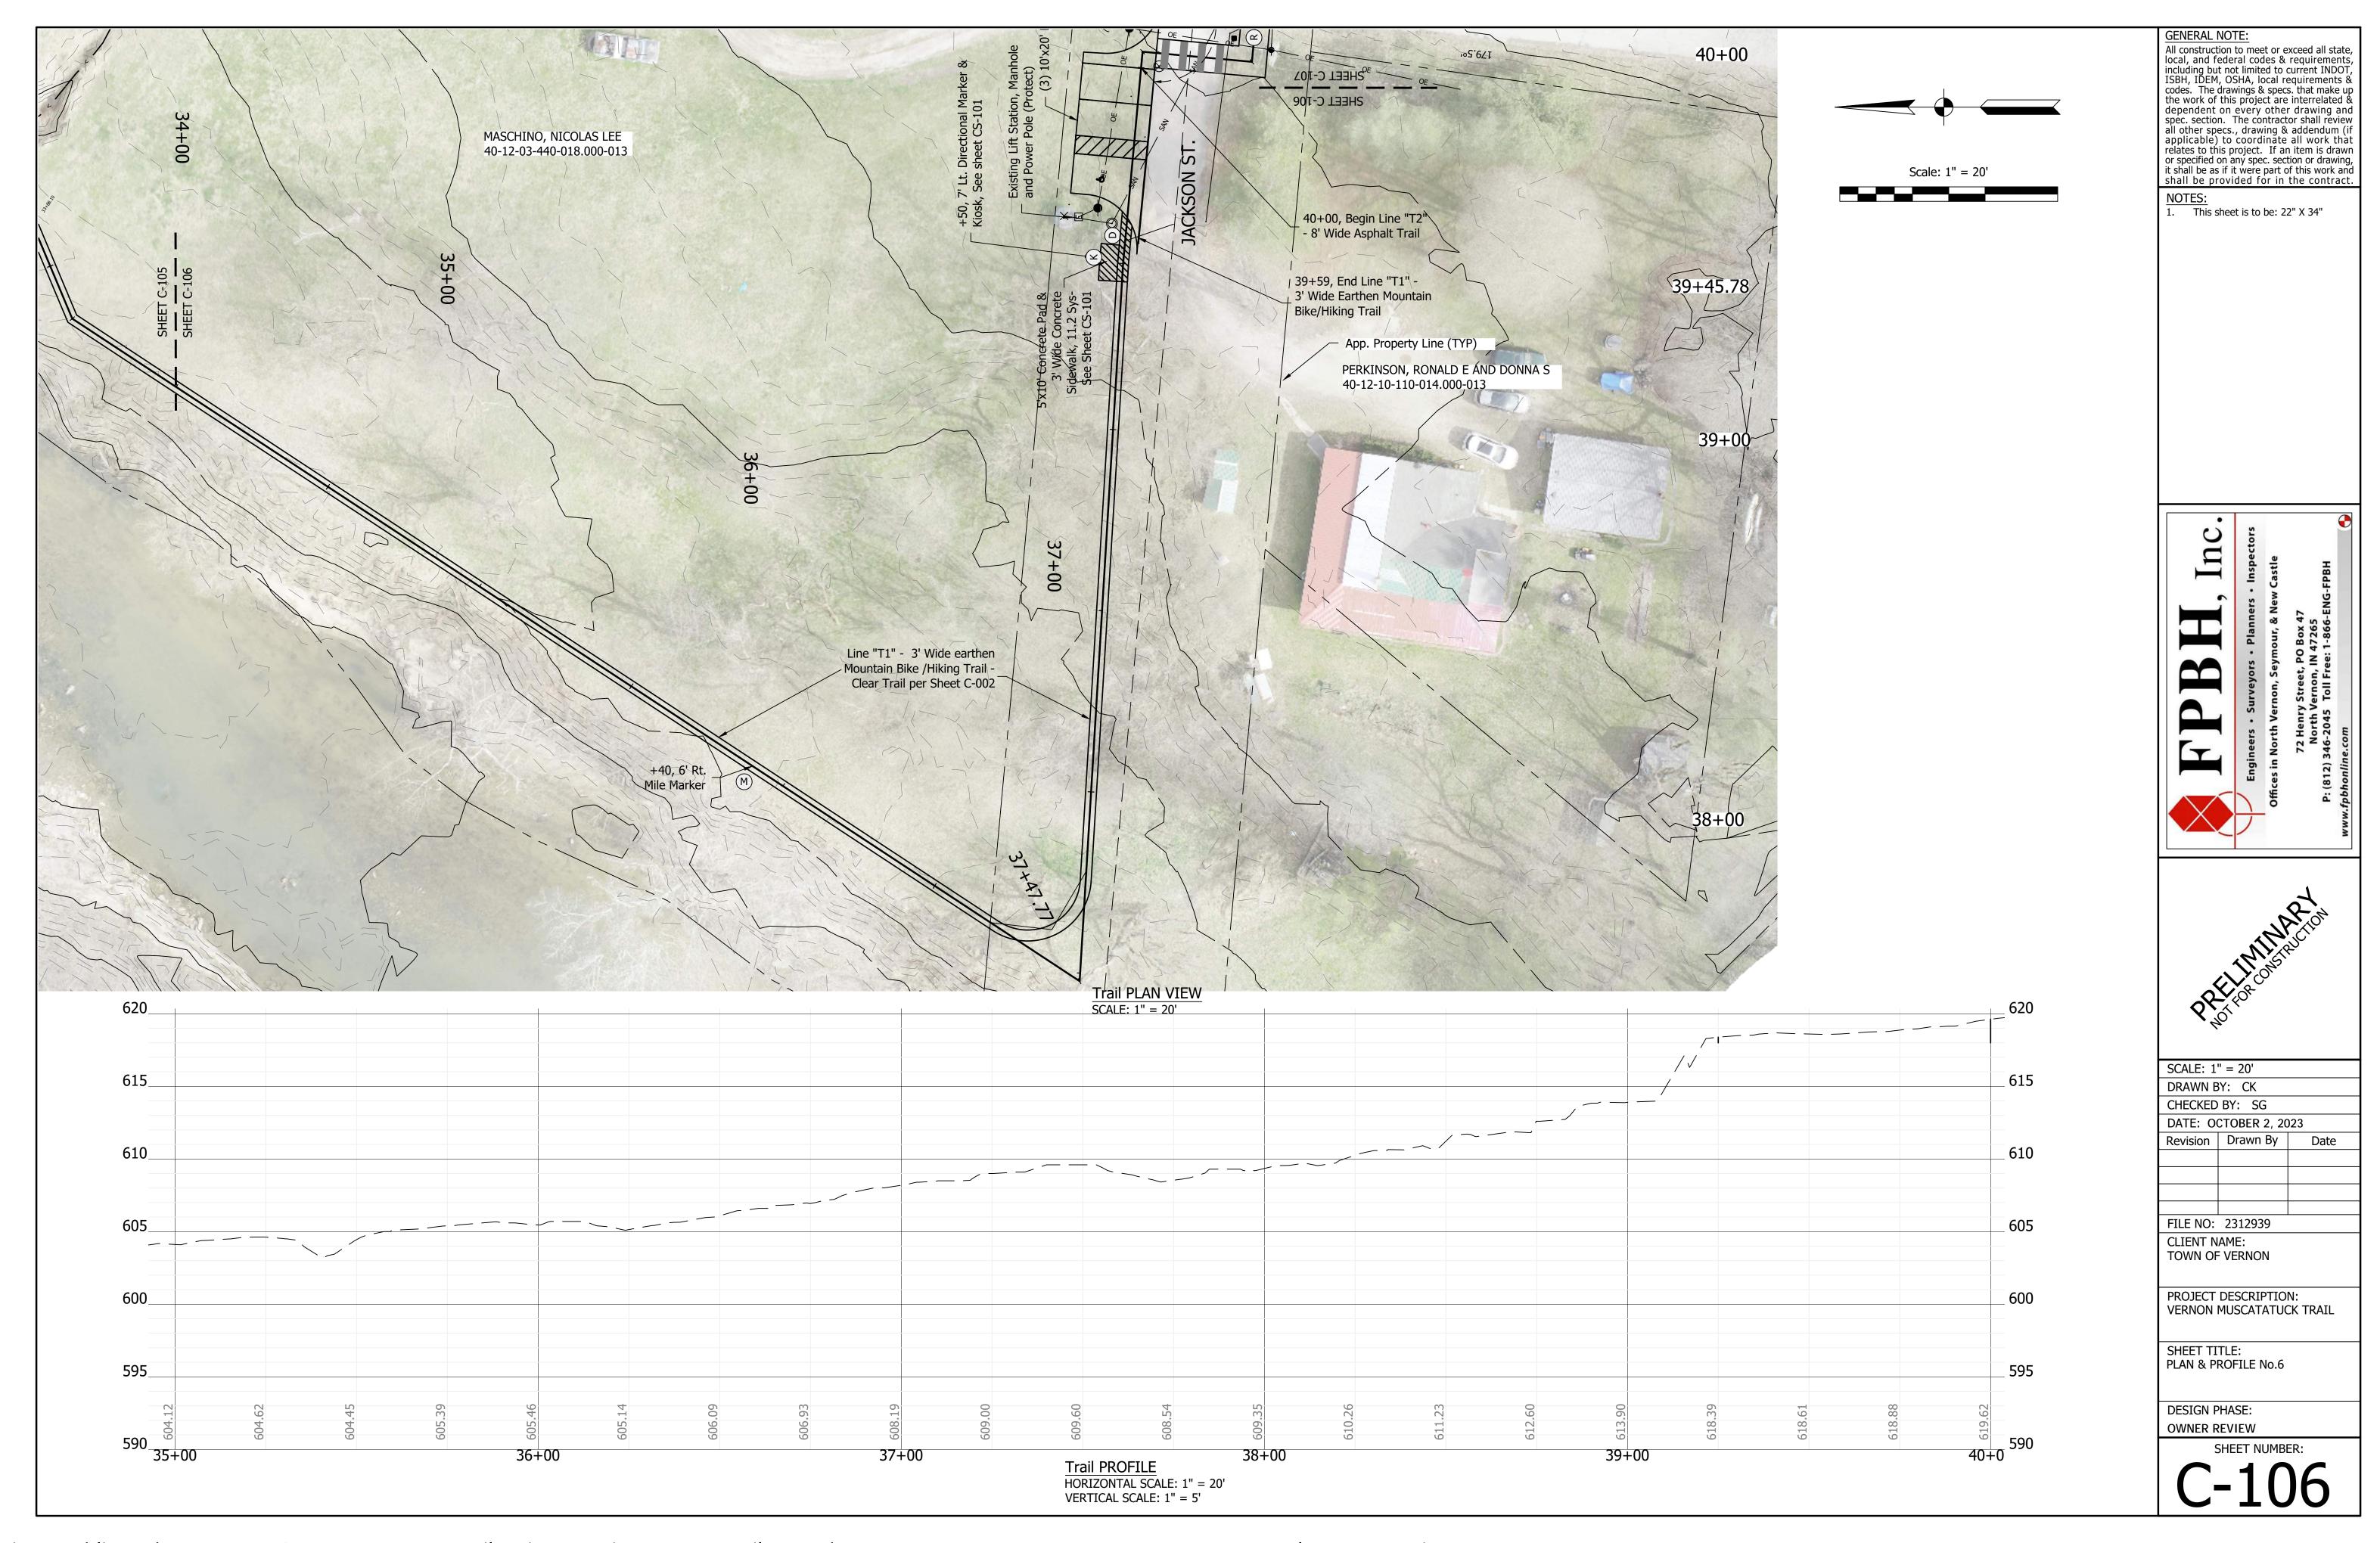


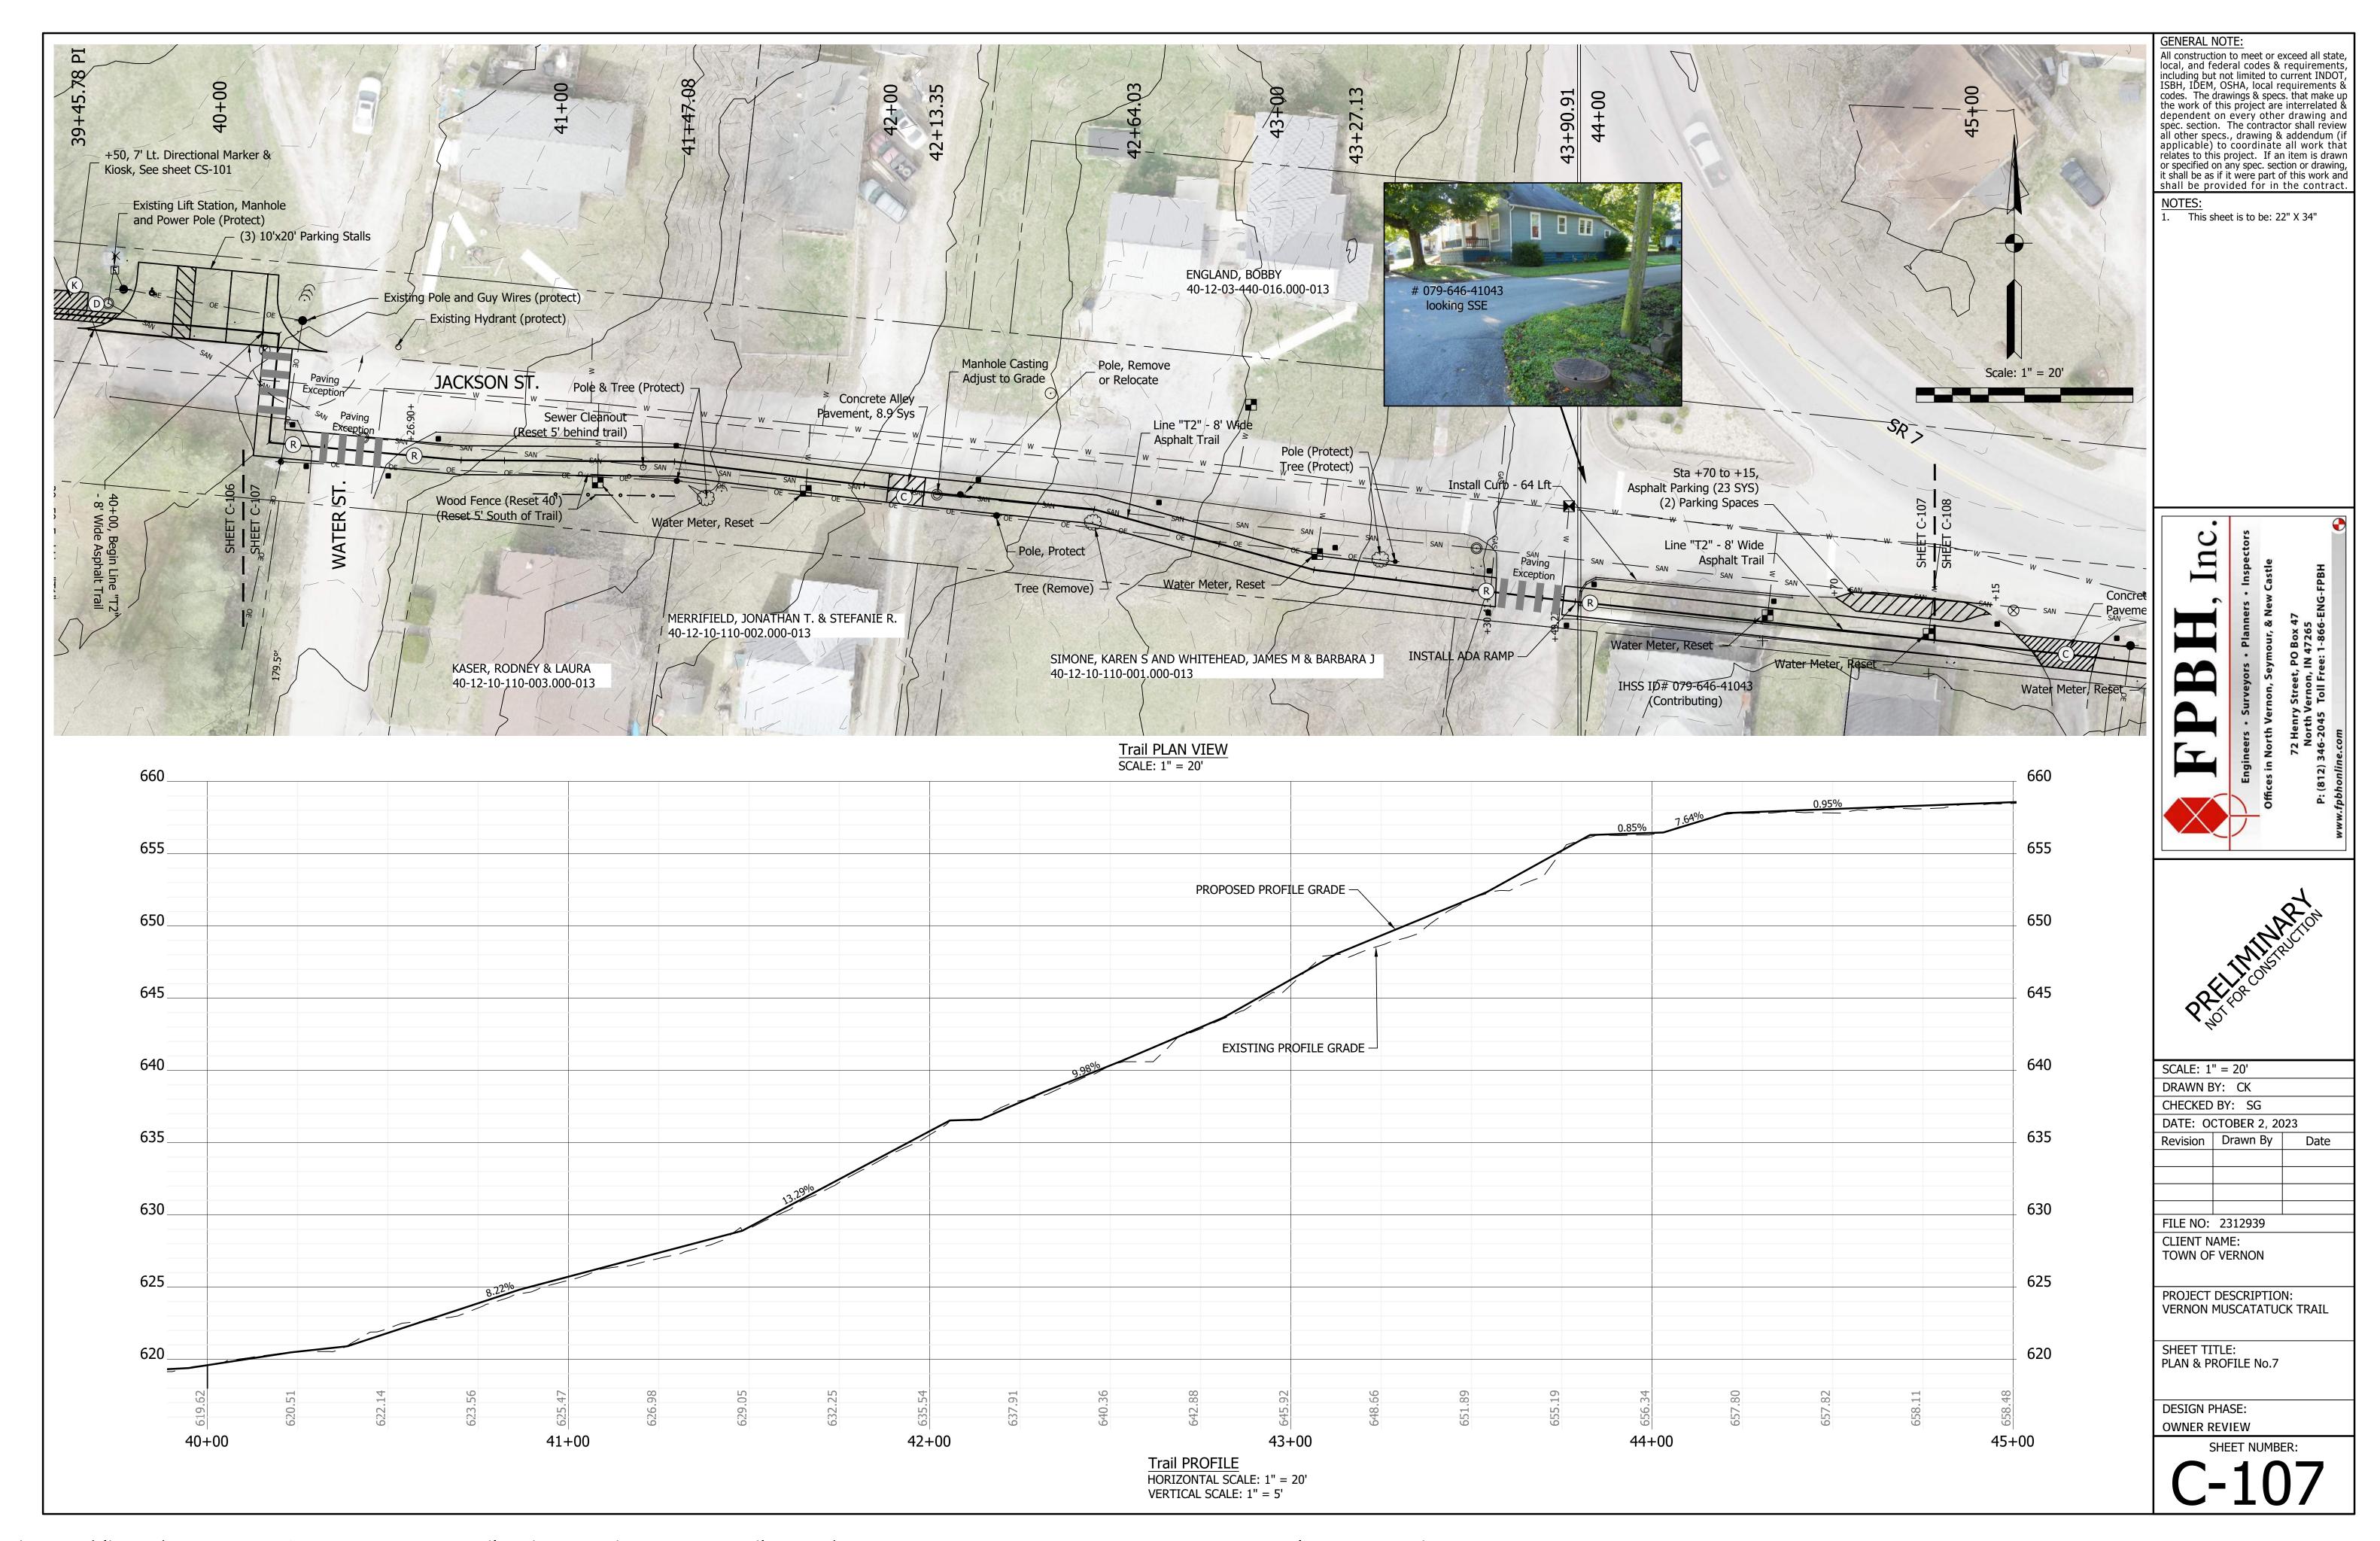


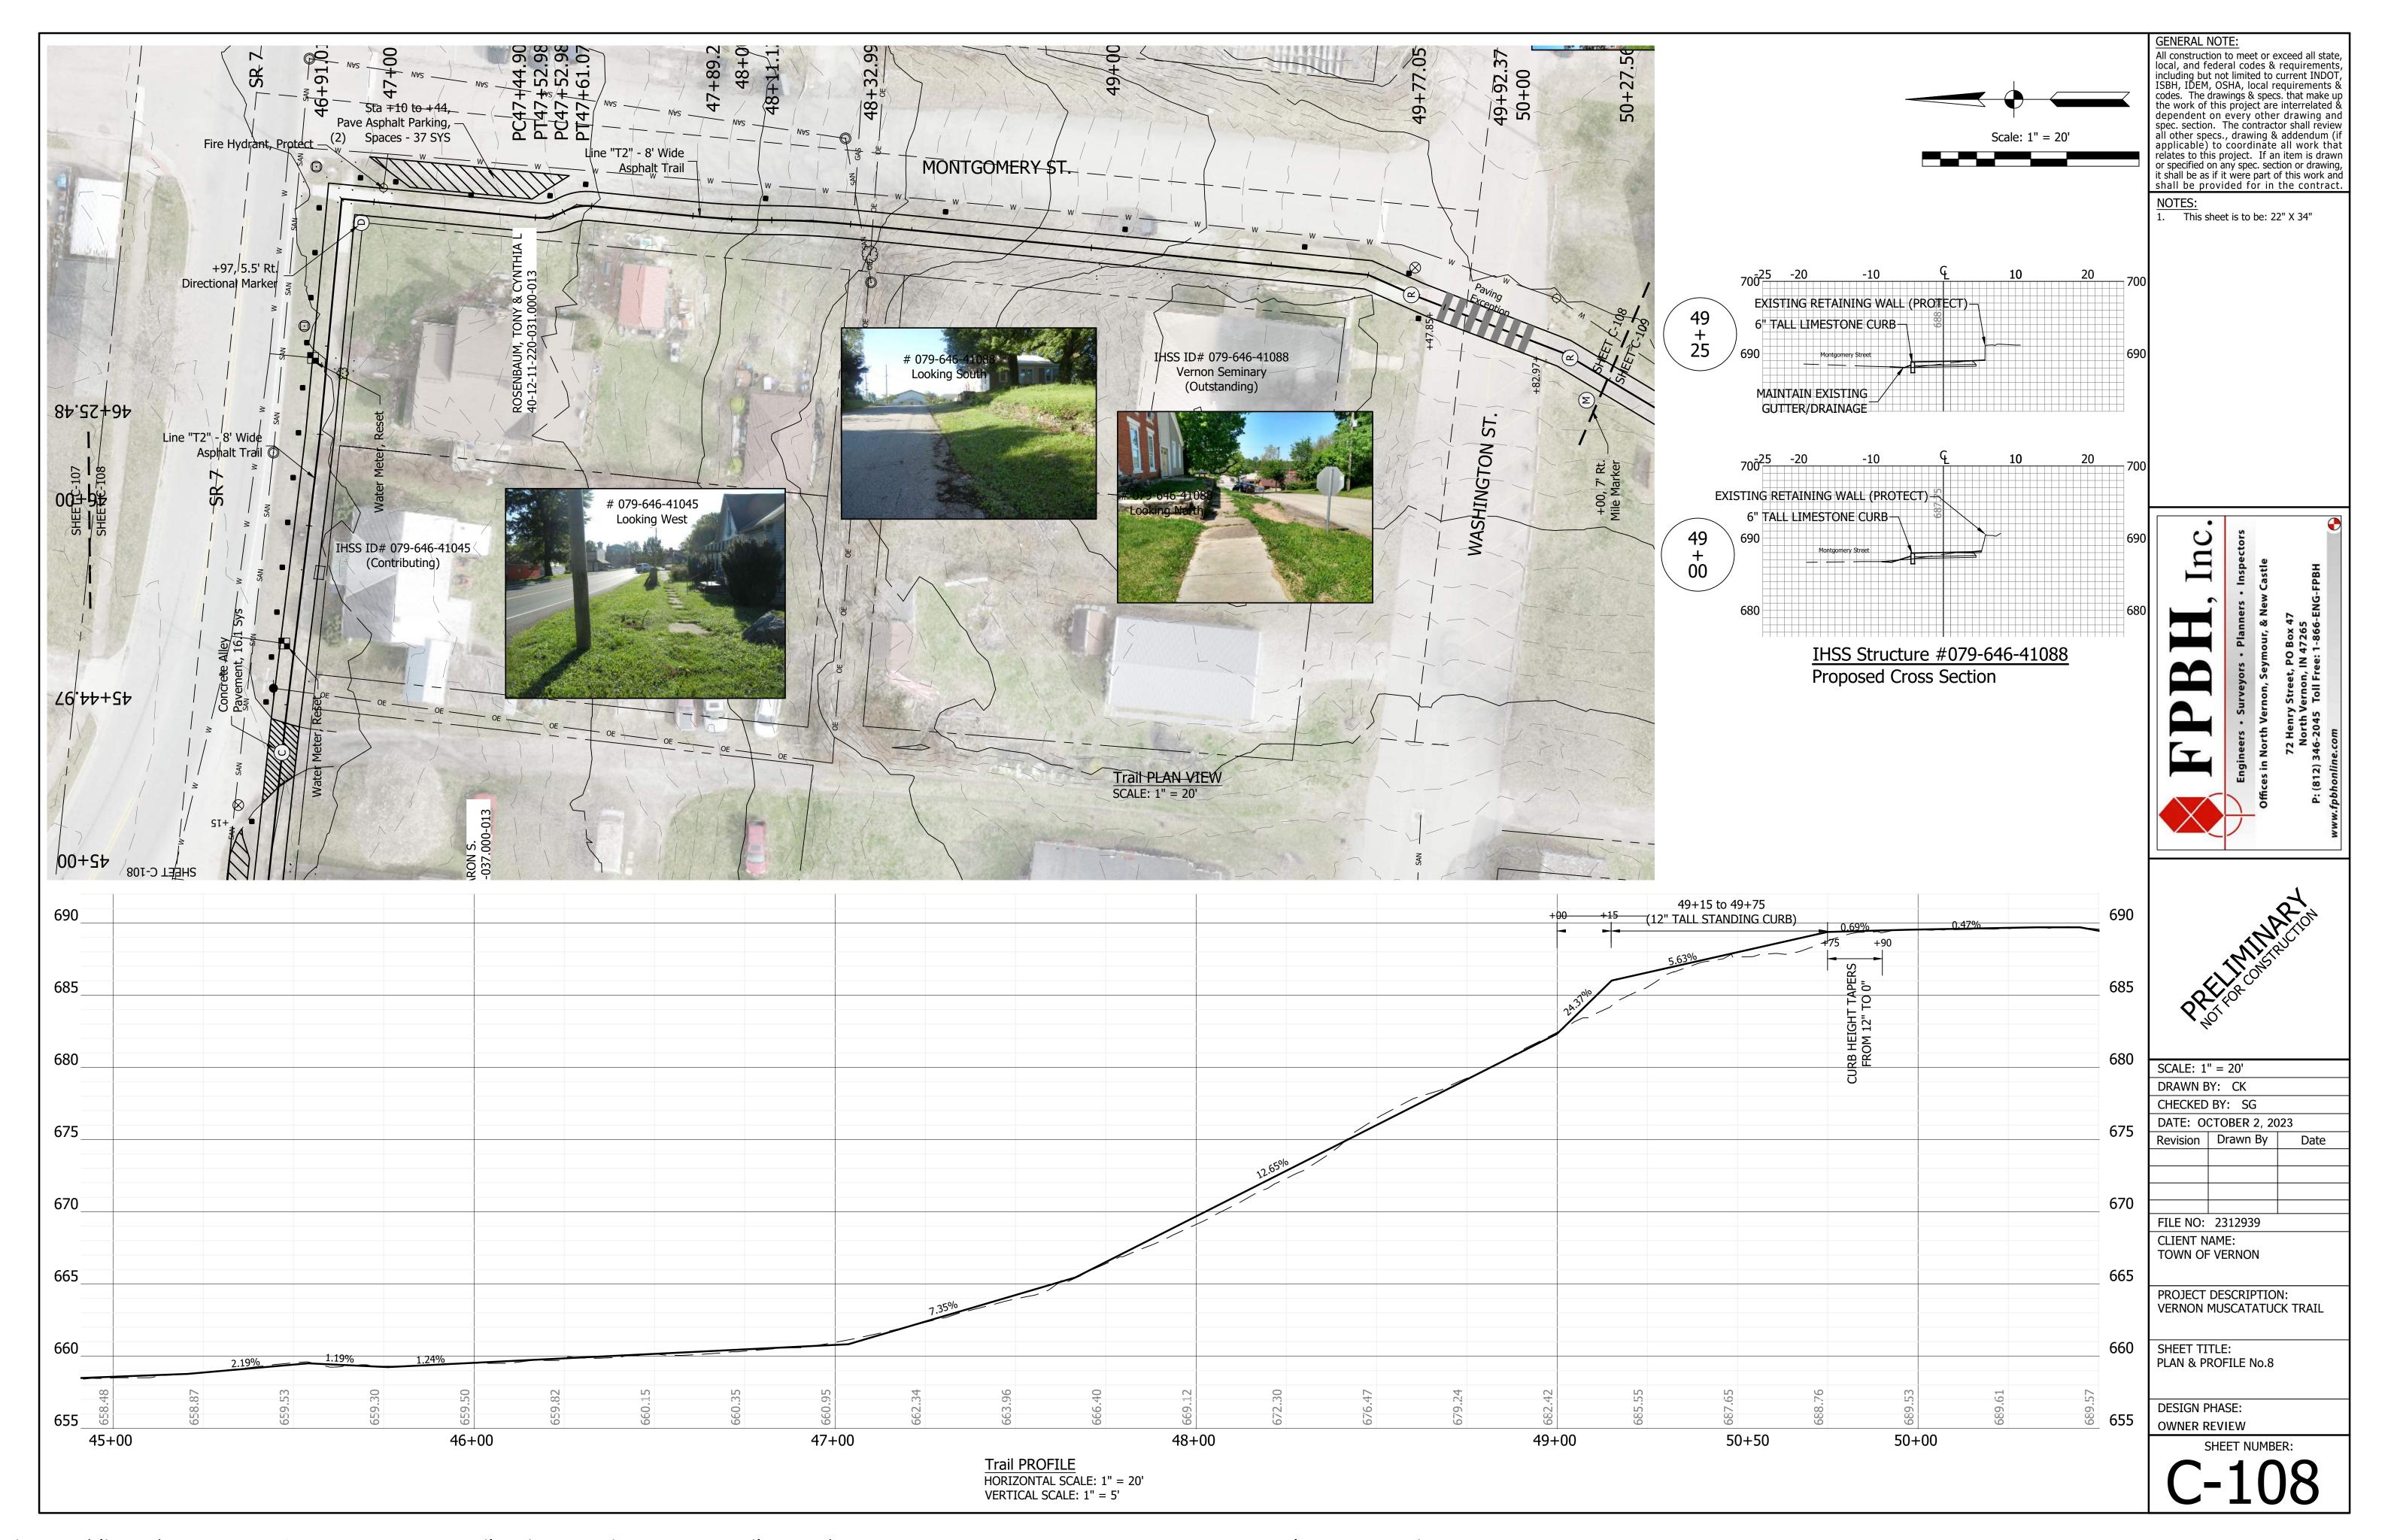

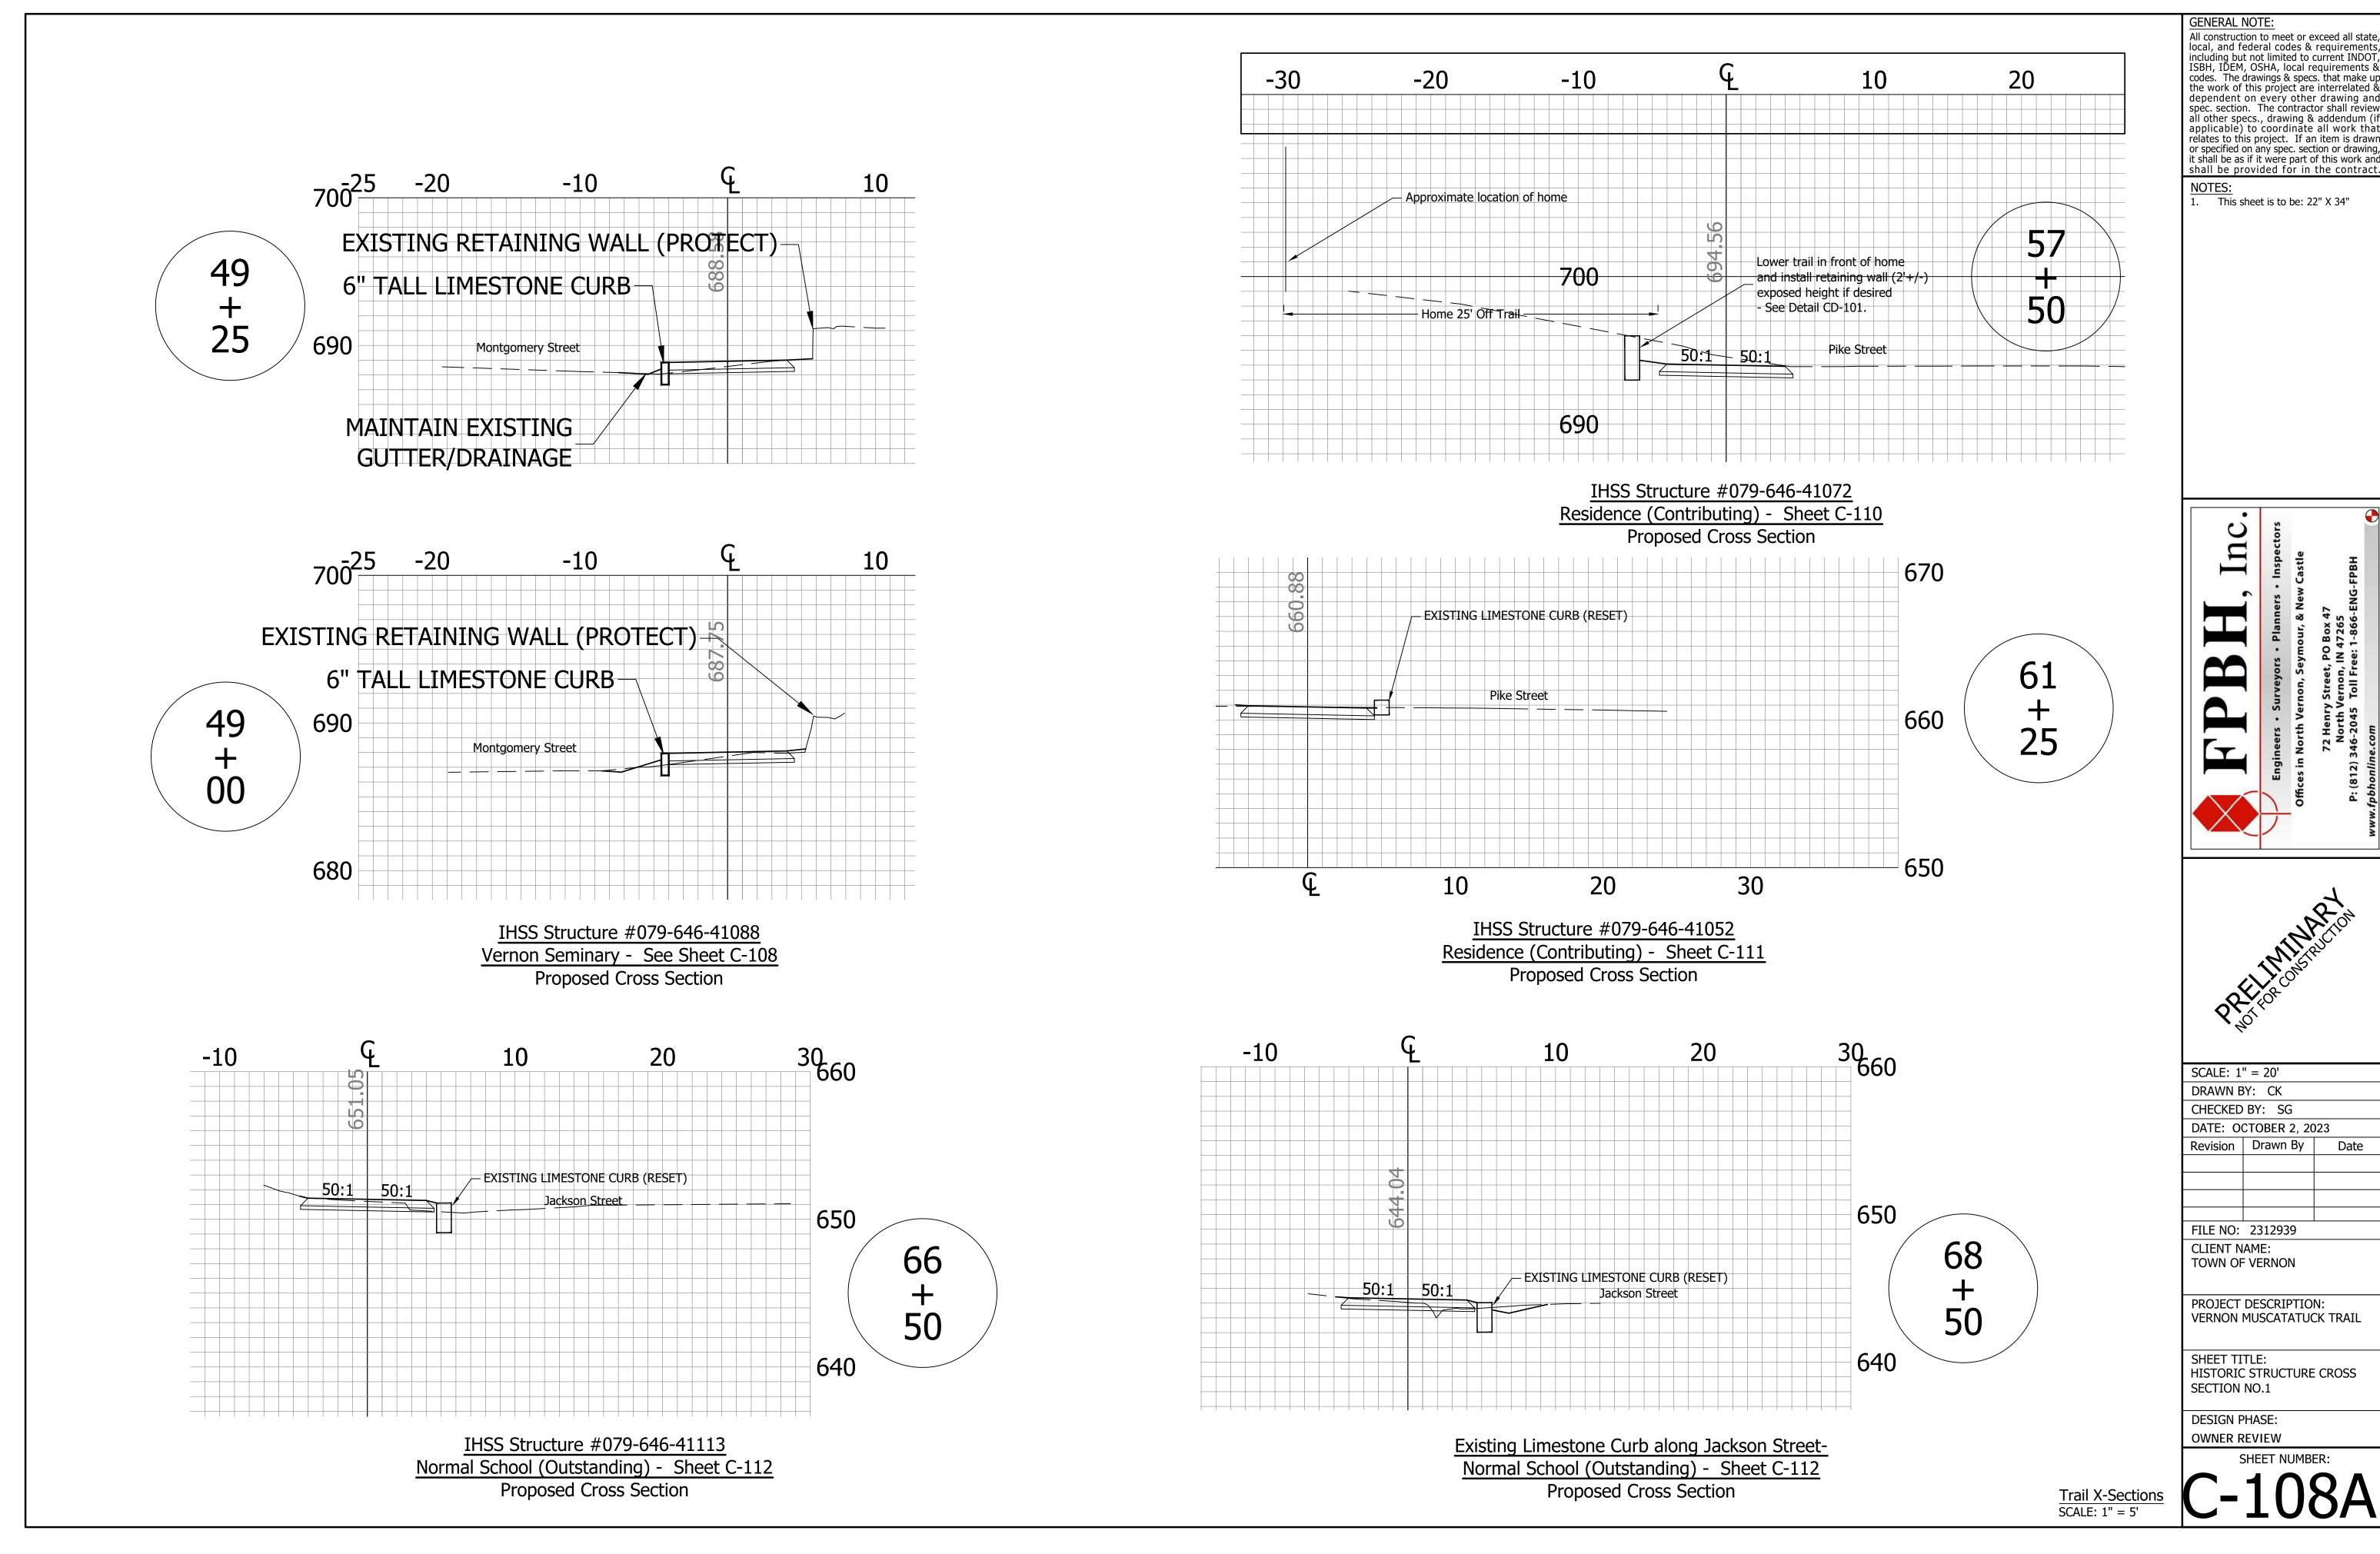





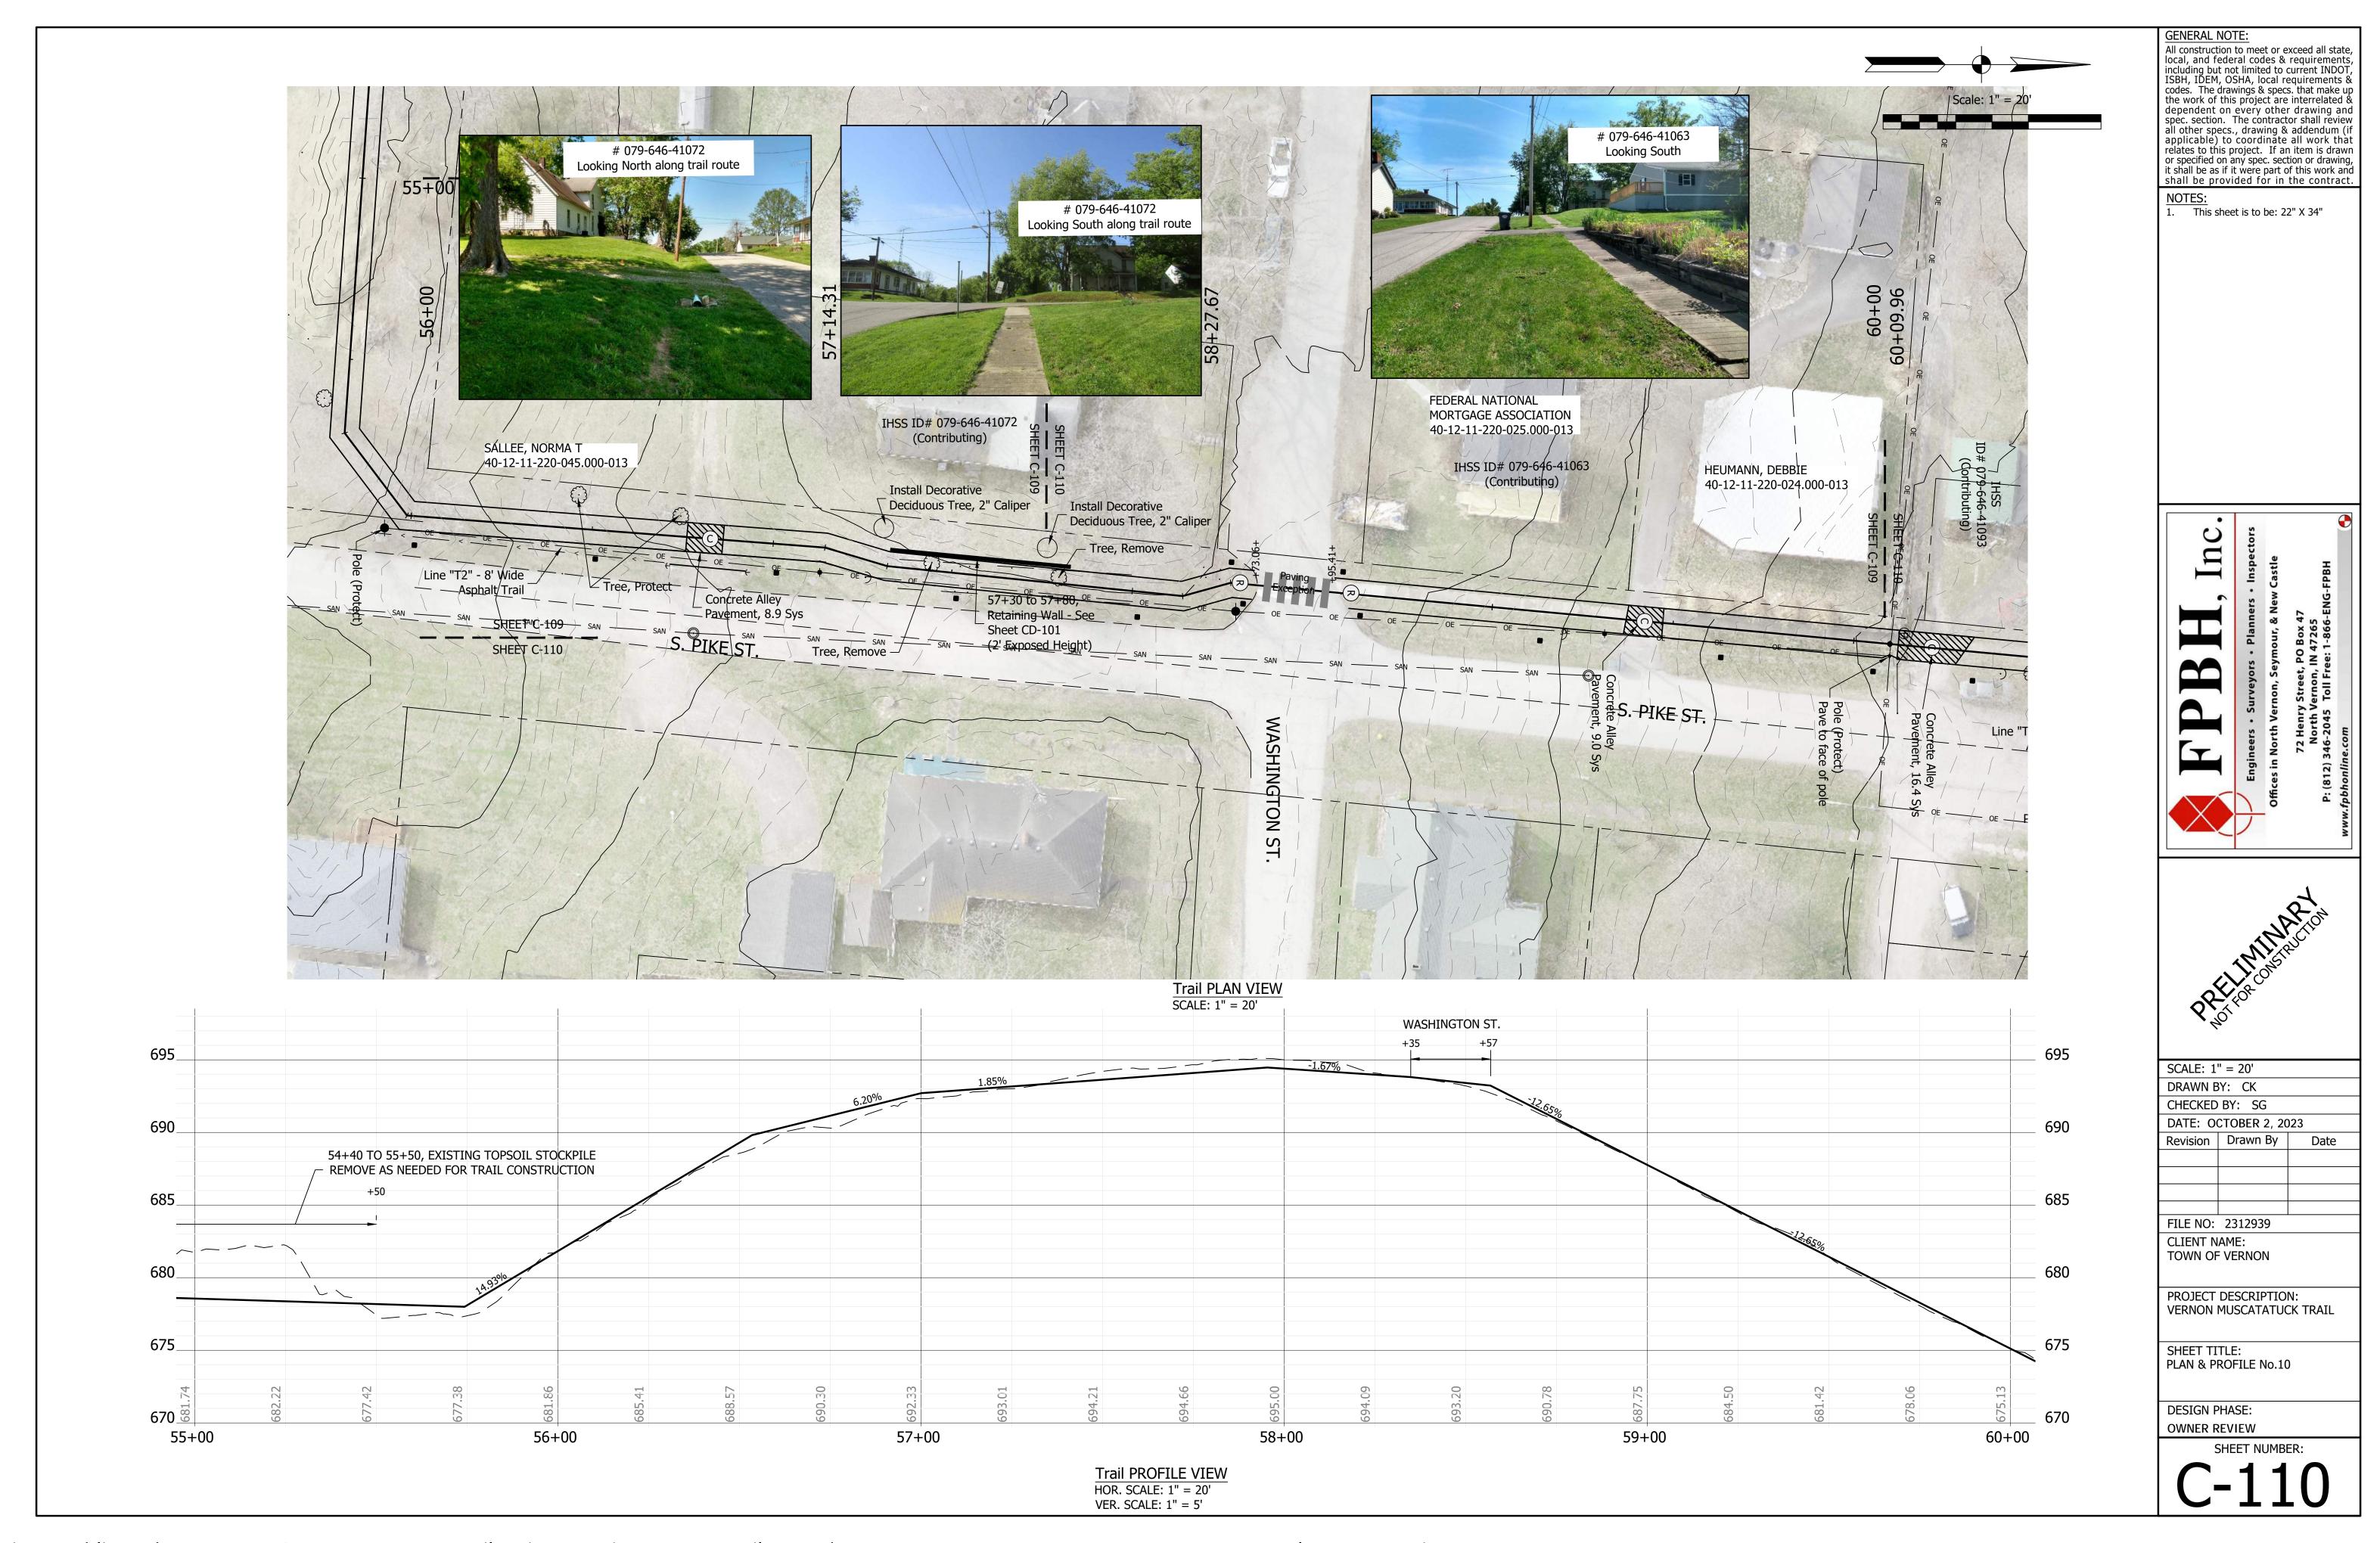


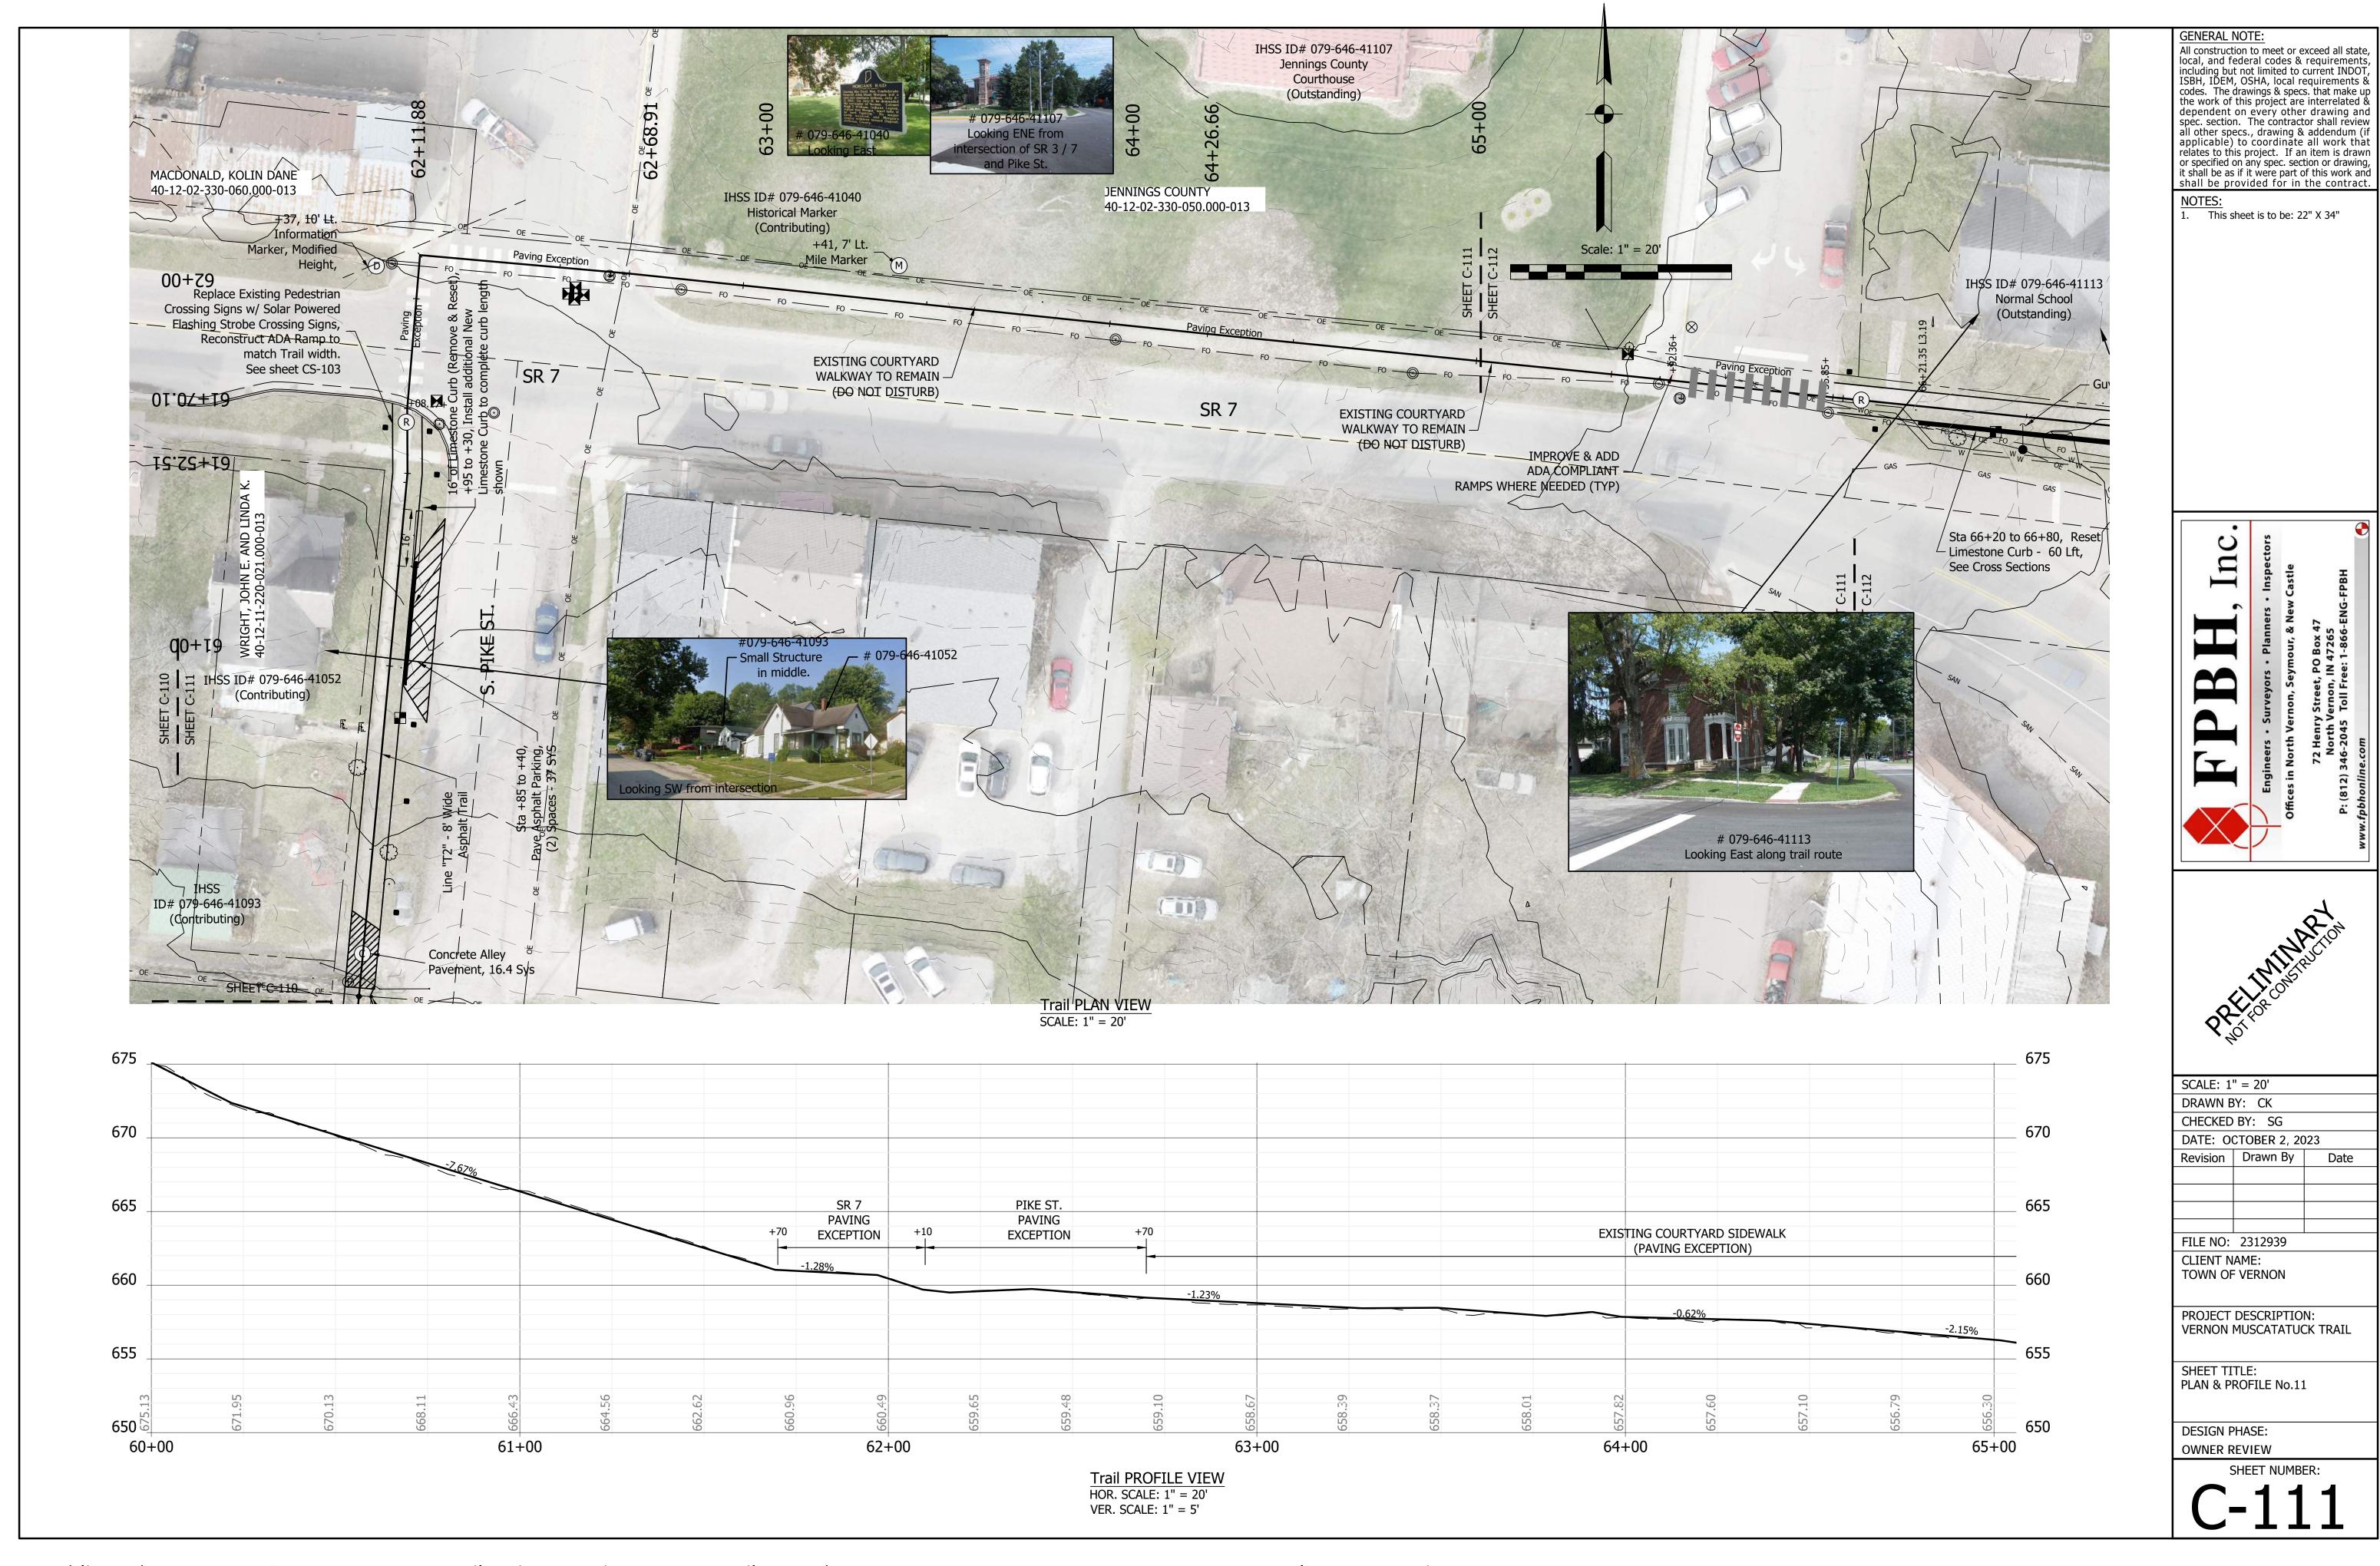




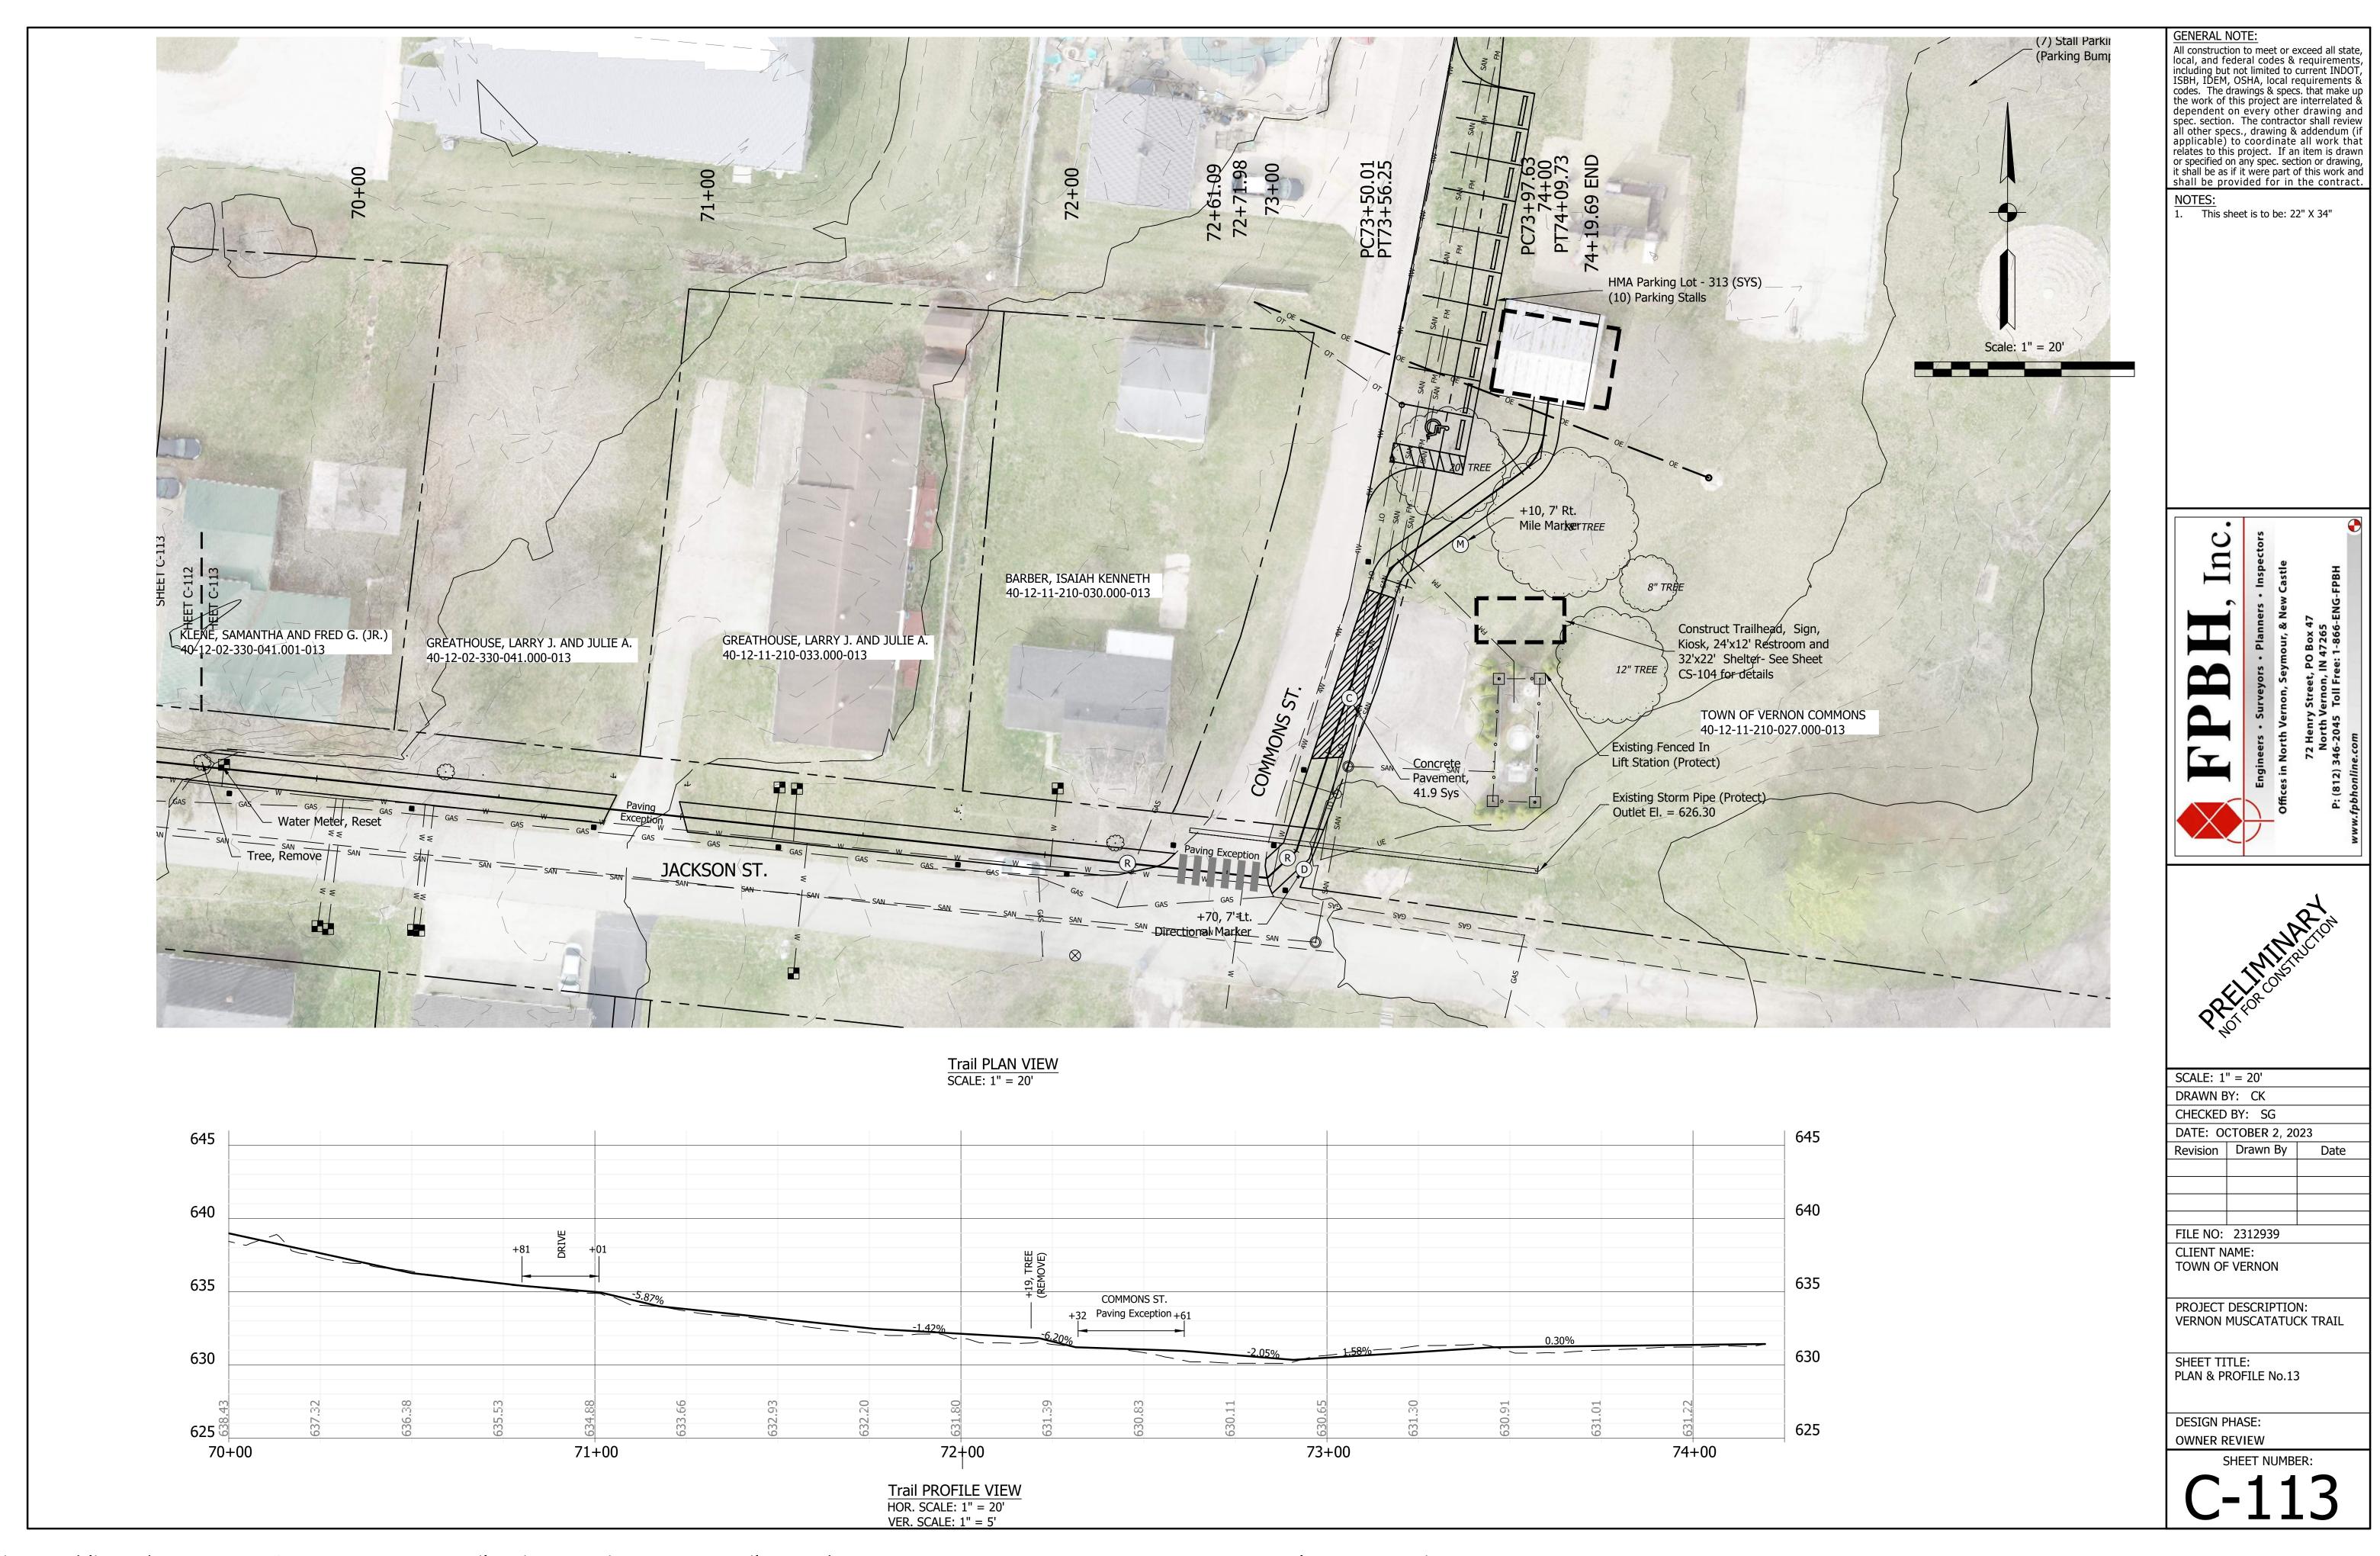


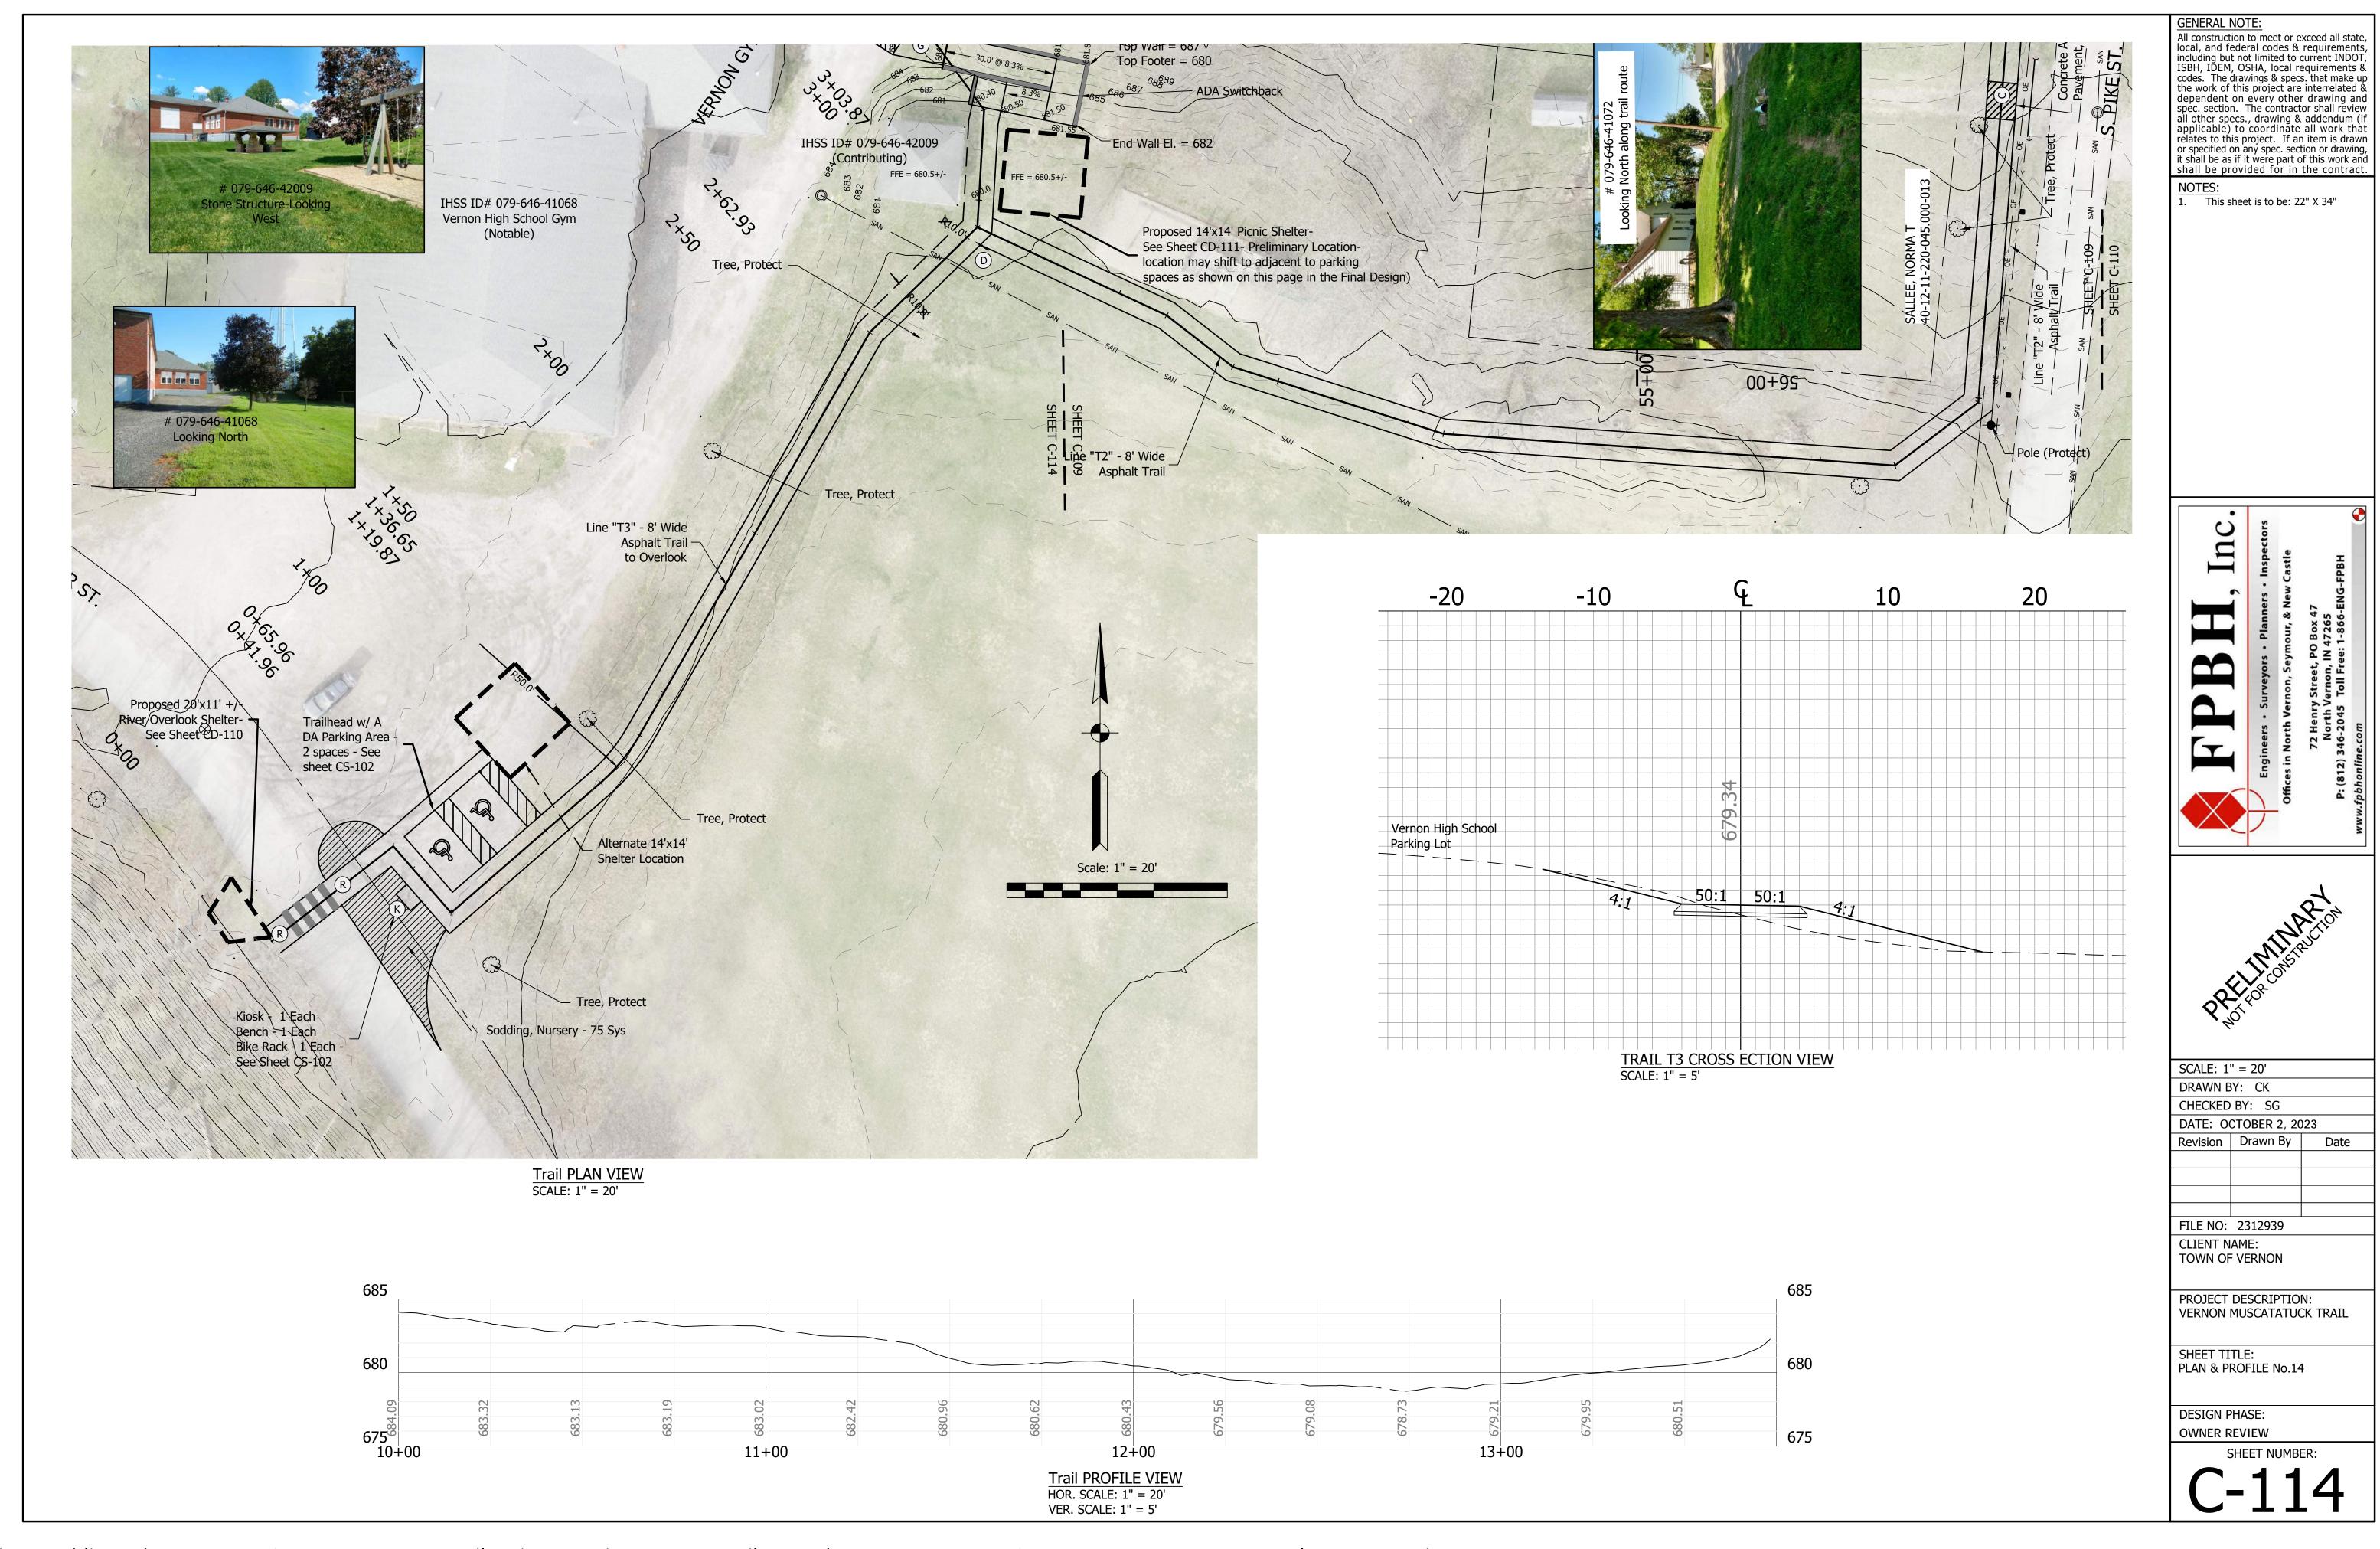


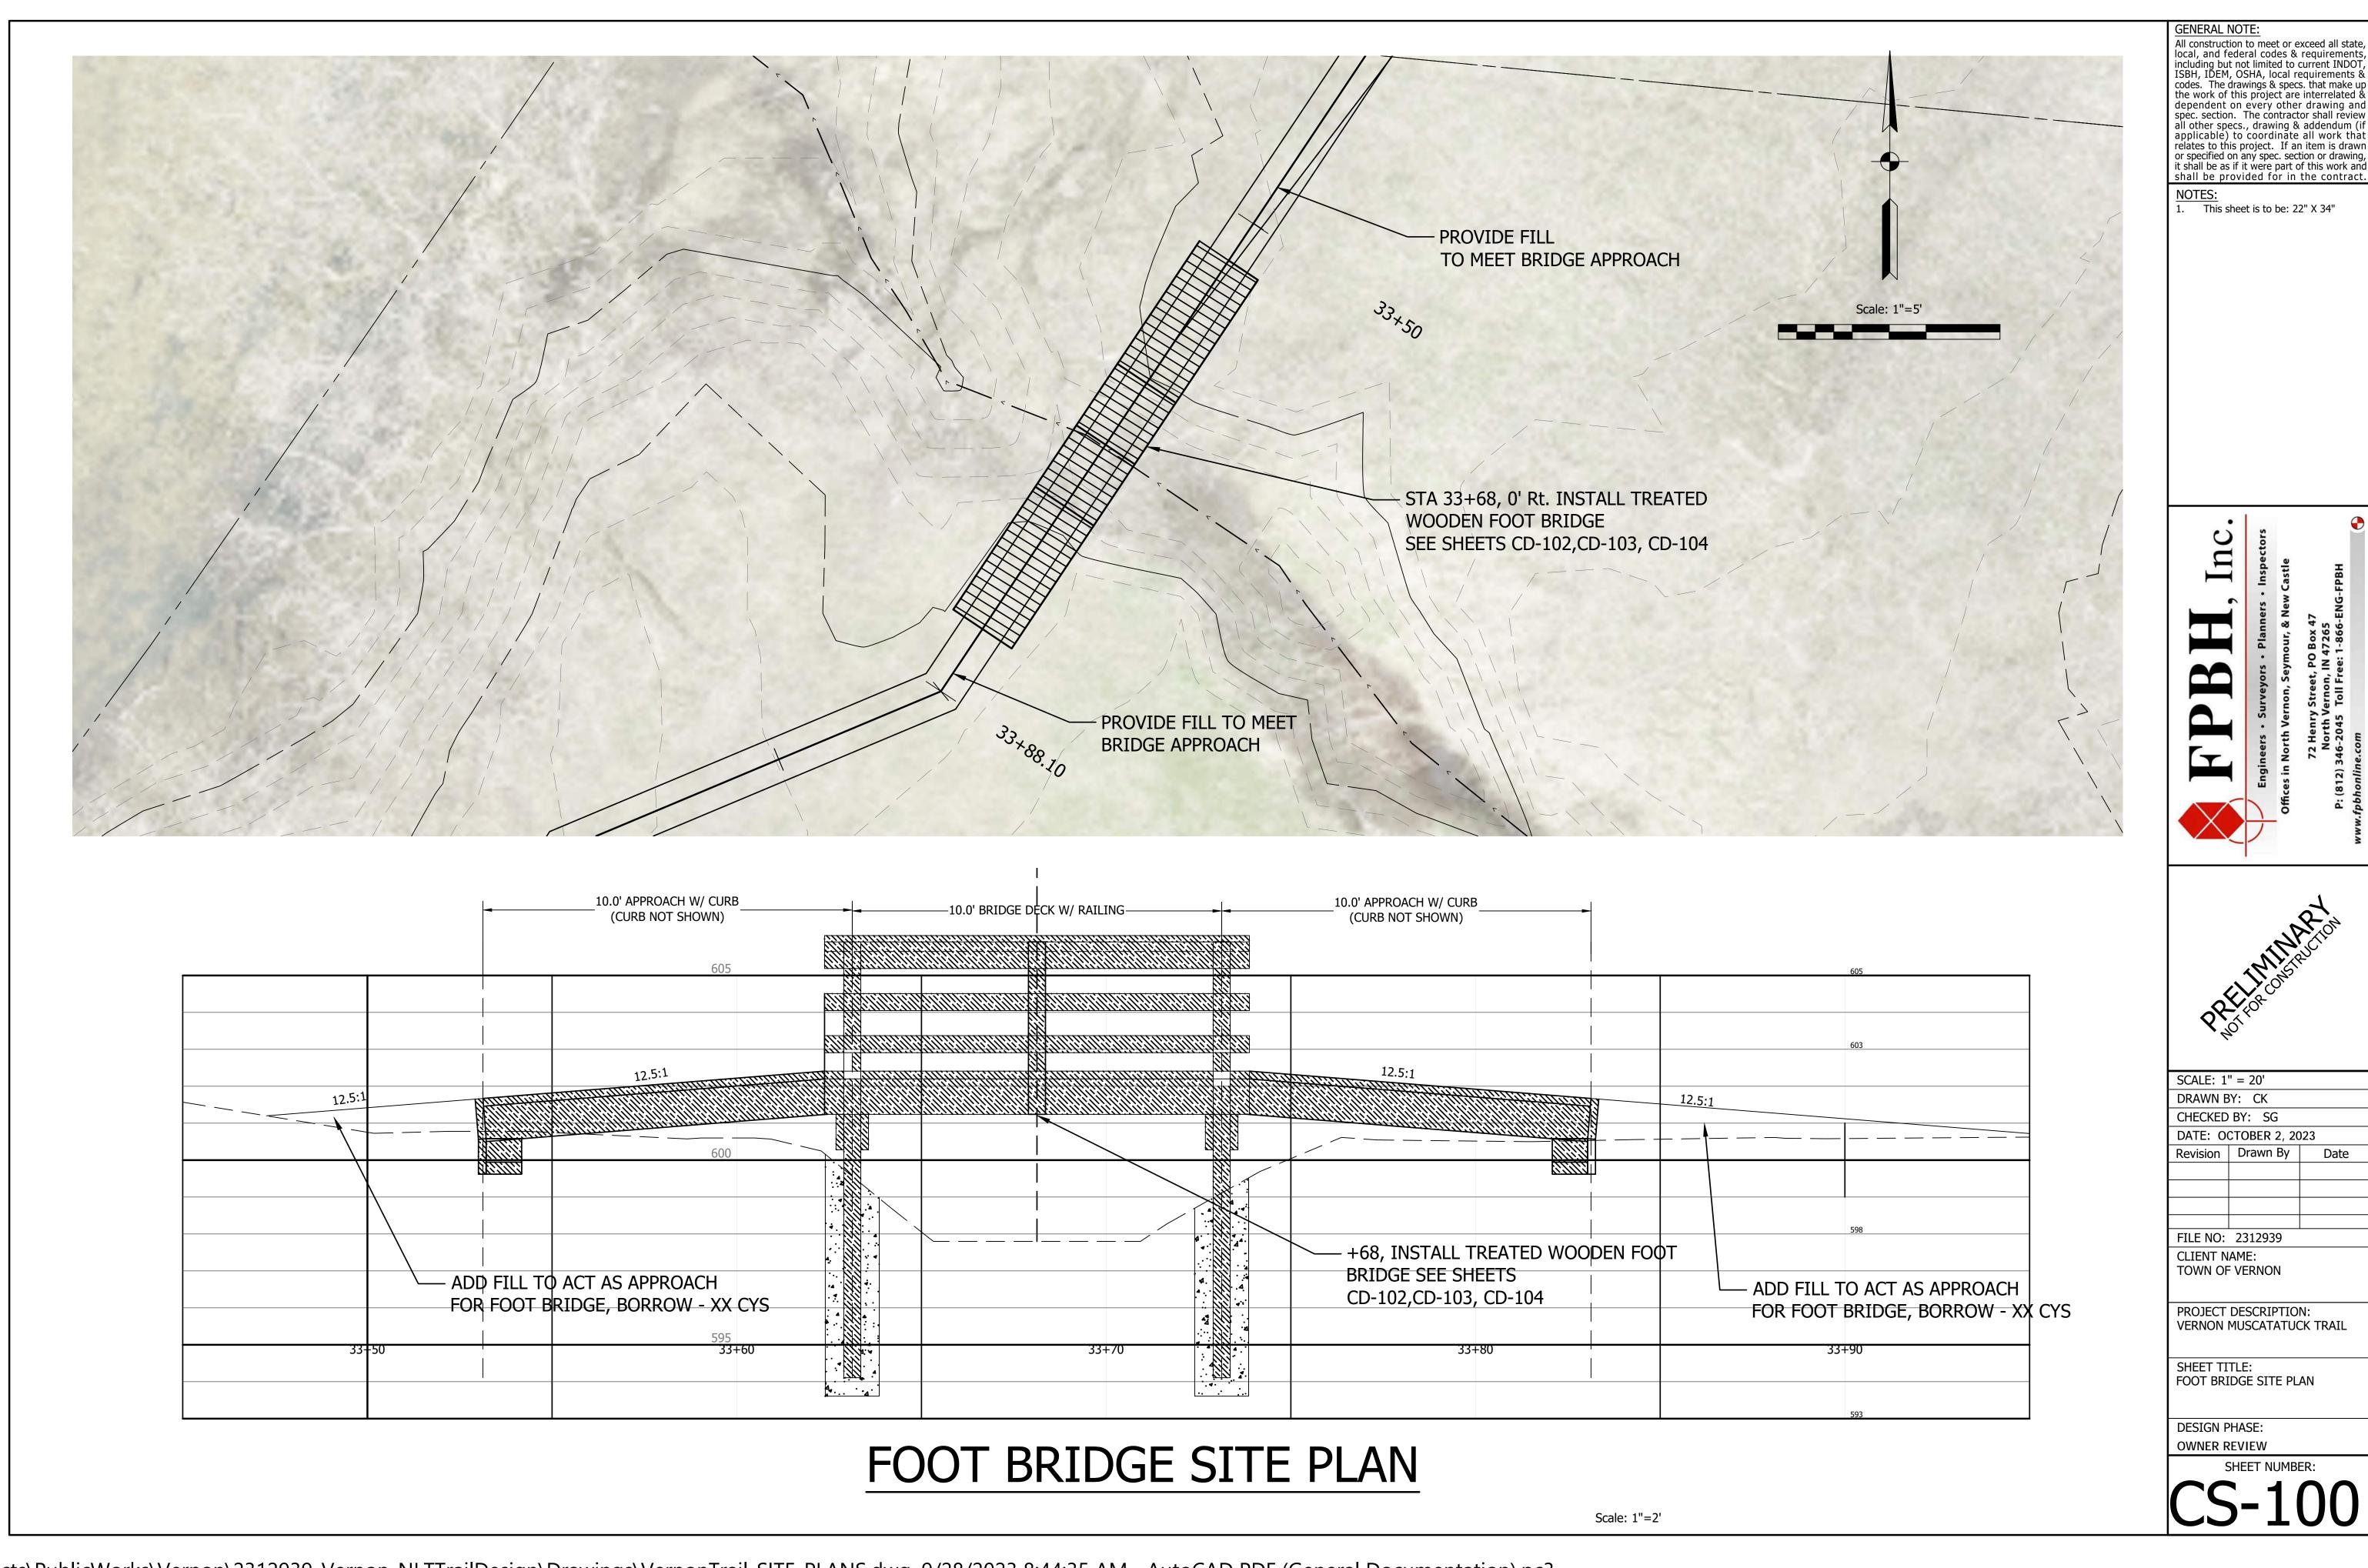



N:\Projects\PublicWorks\Vernon\2312939\_Vernon\_NLTTrailDesign\Drawings\VernonTrail\_SITE\_PLANS.dwg, 9/28/2023 8:44:35 AM, \_AutoCAD PDF (General Documentation).pc3

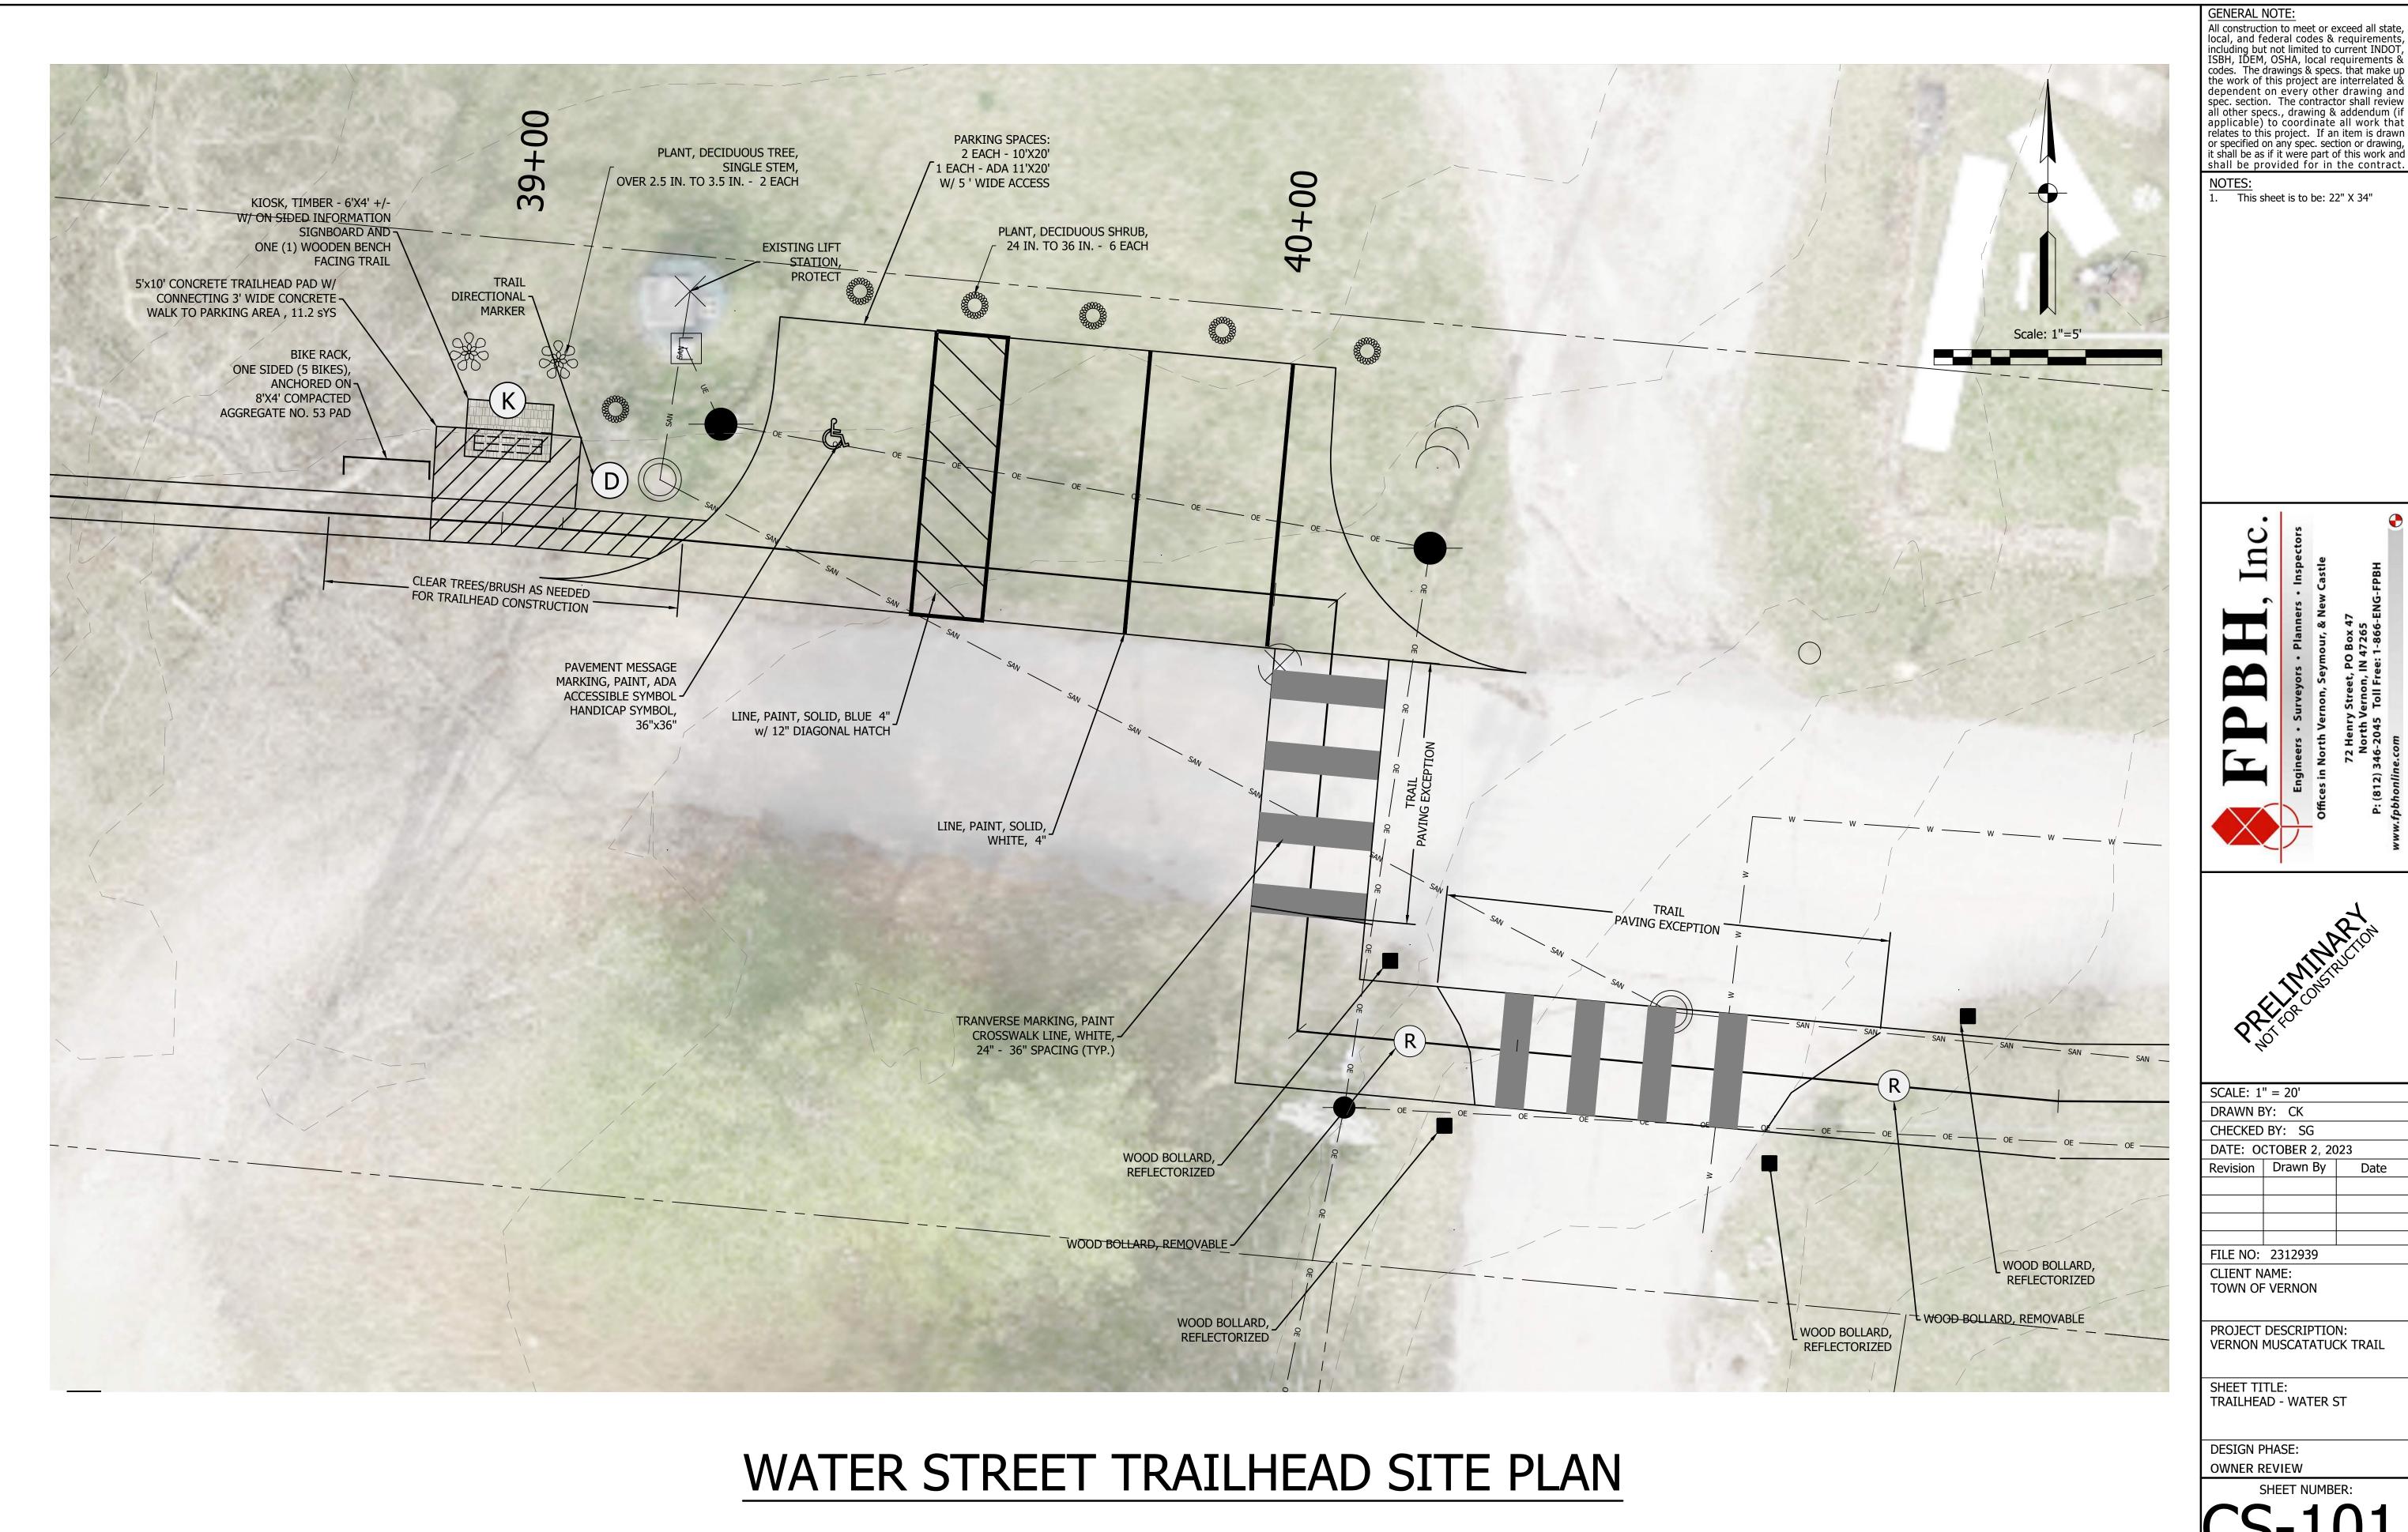

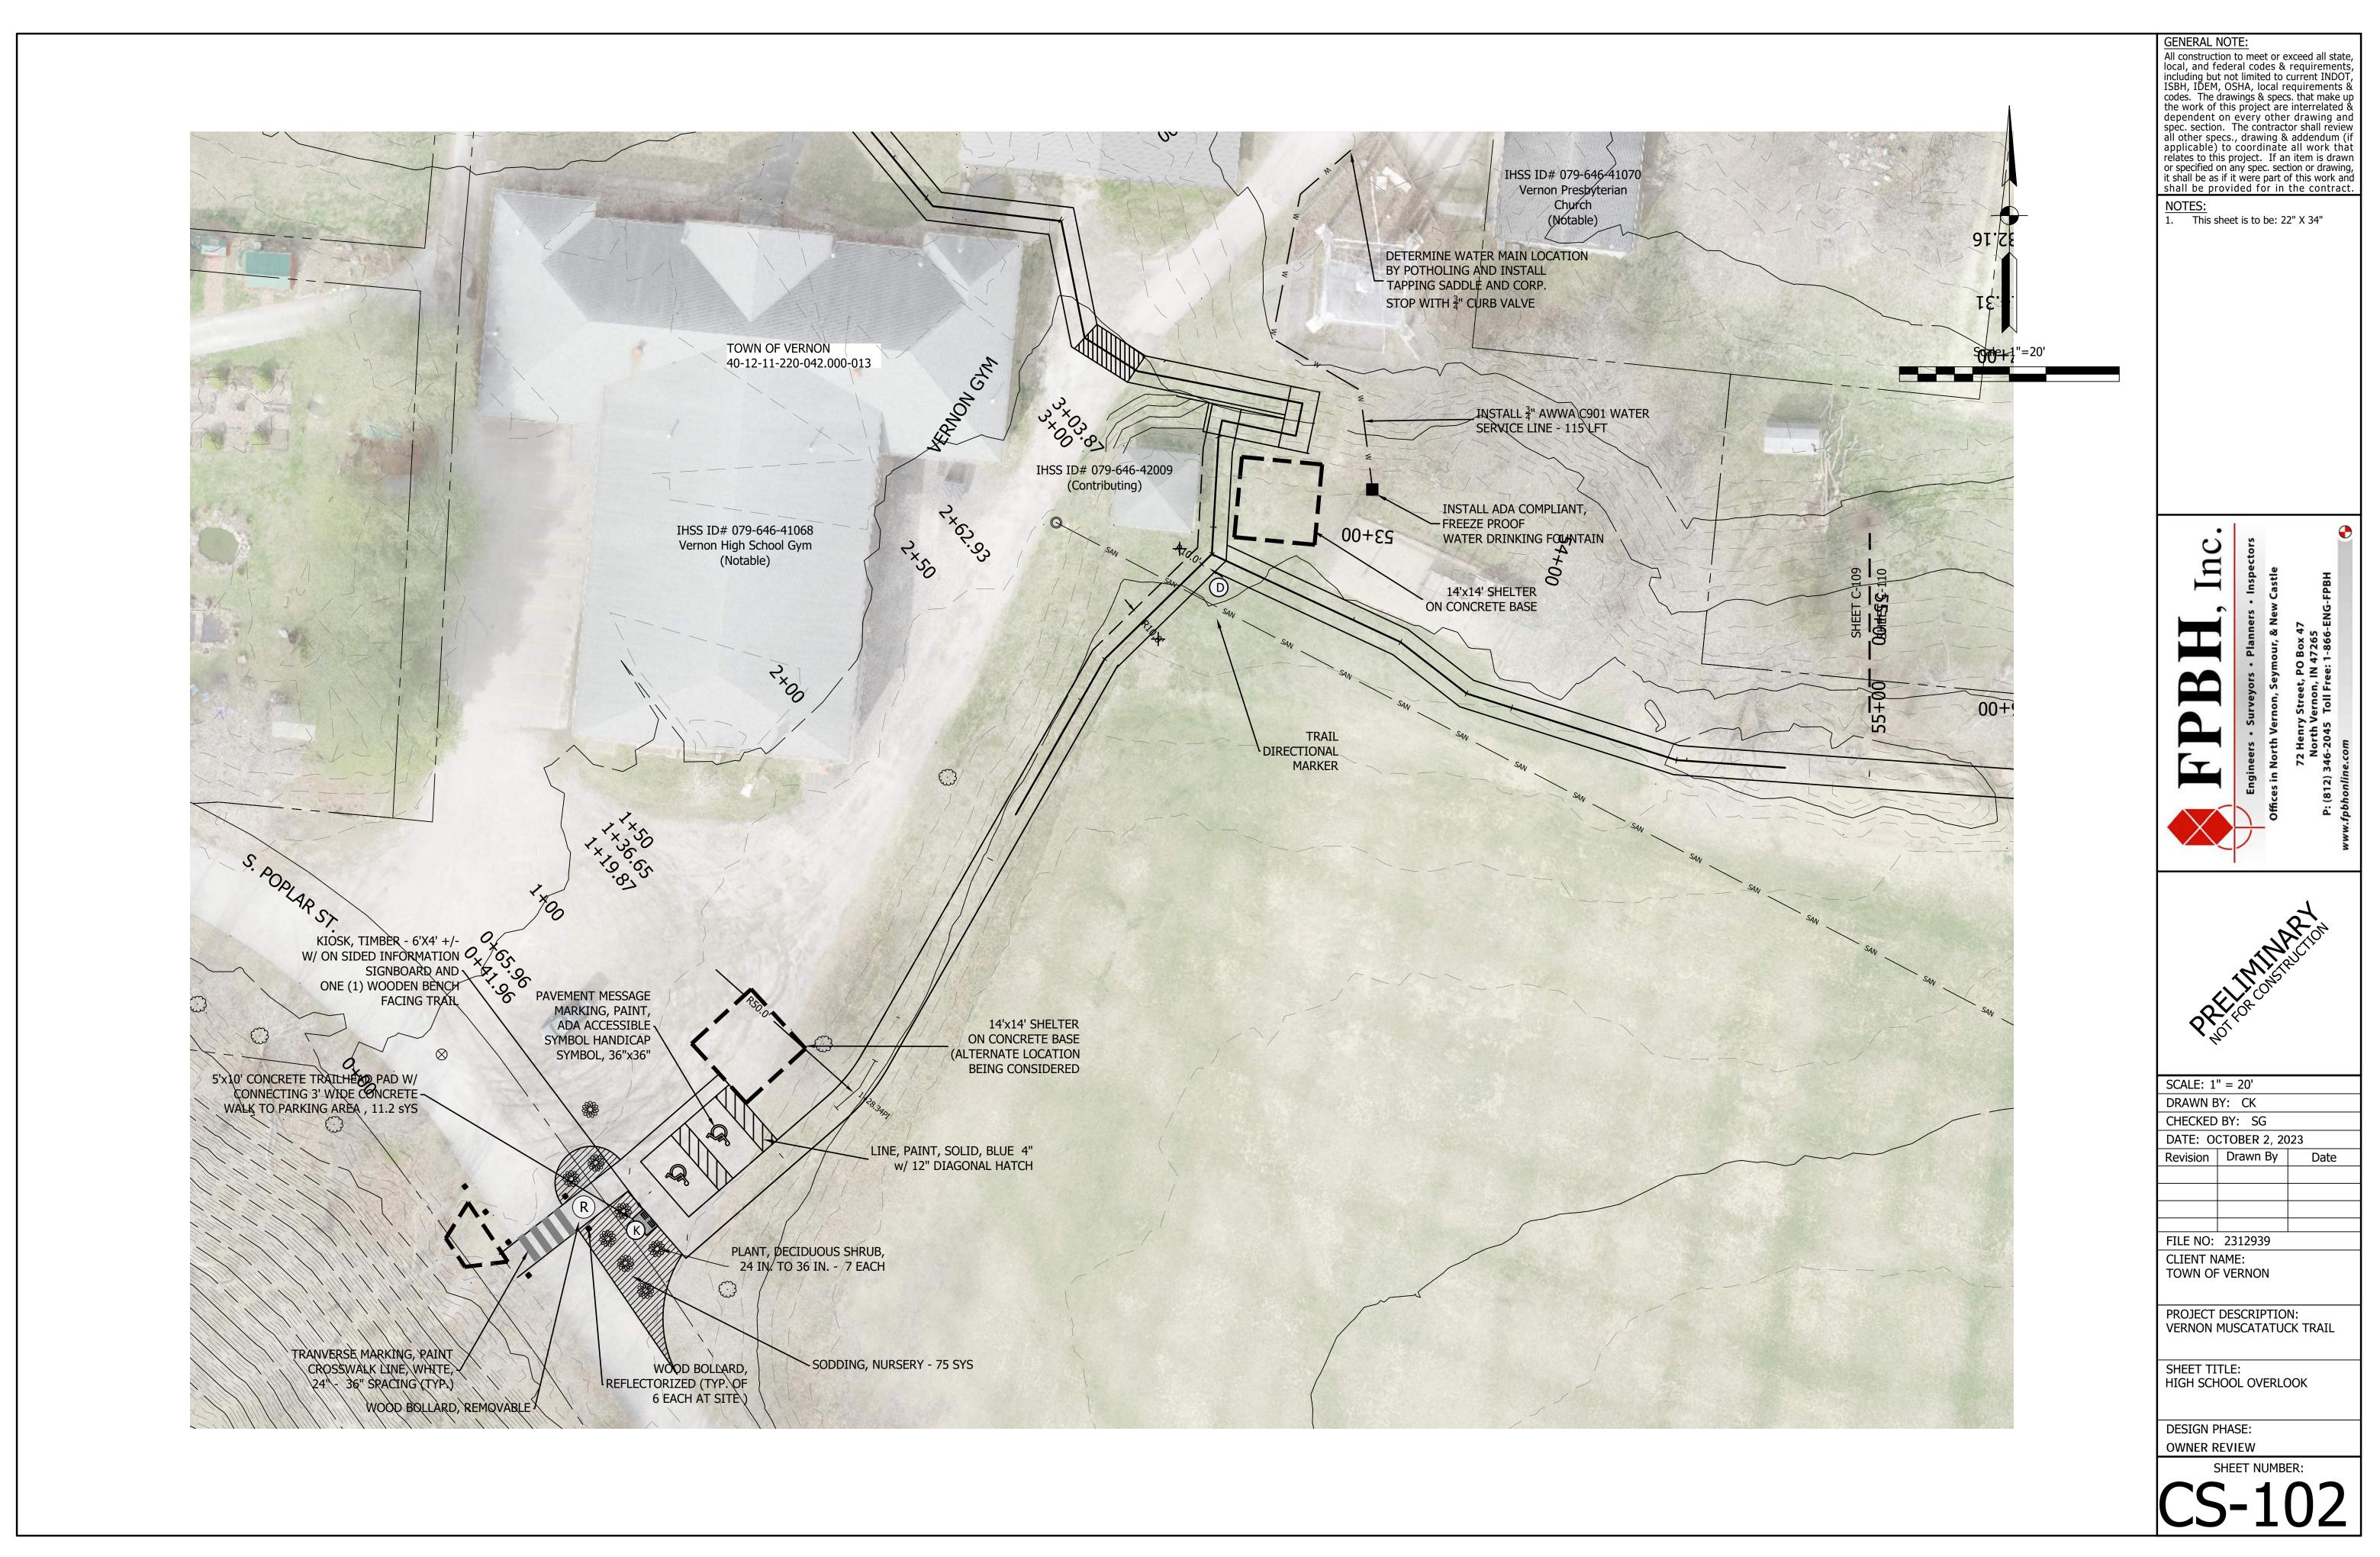

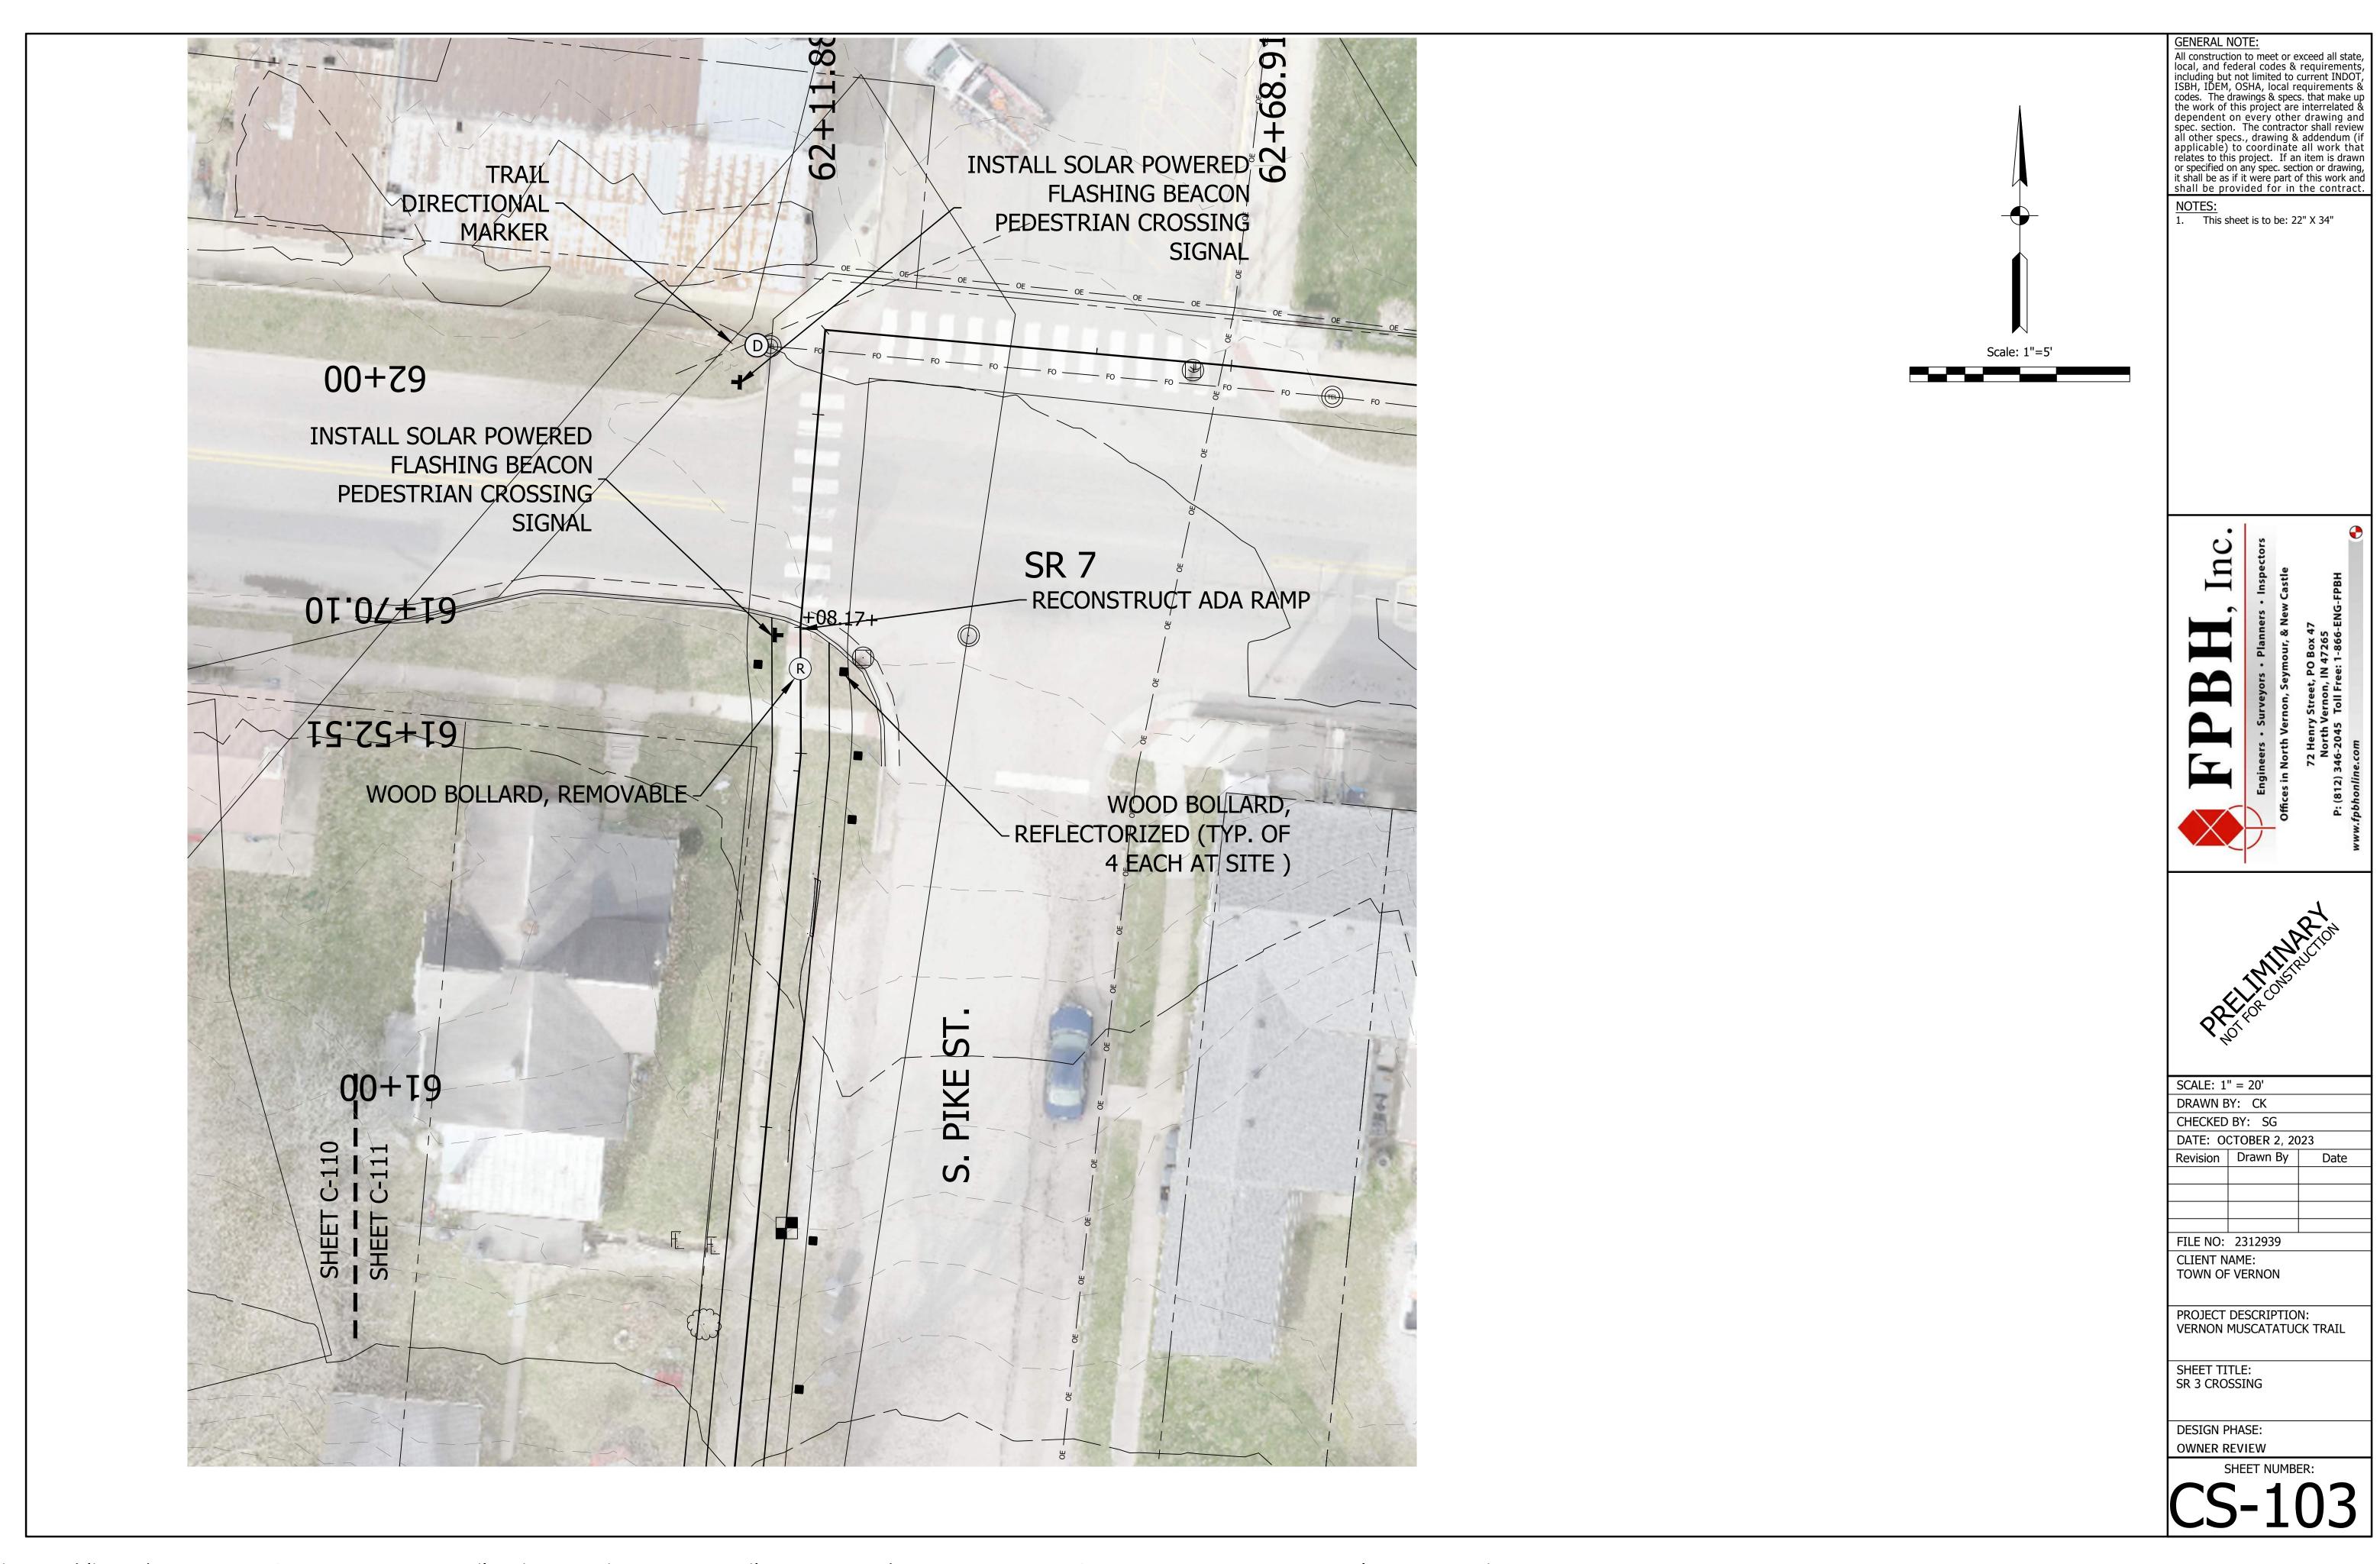

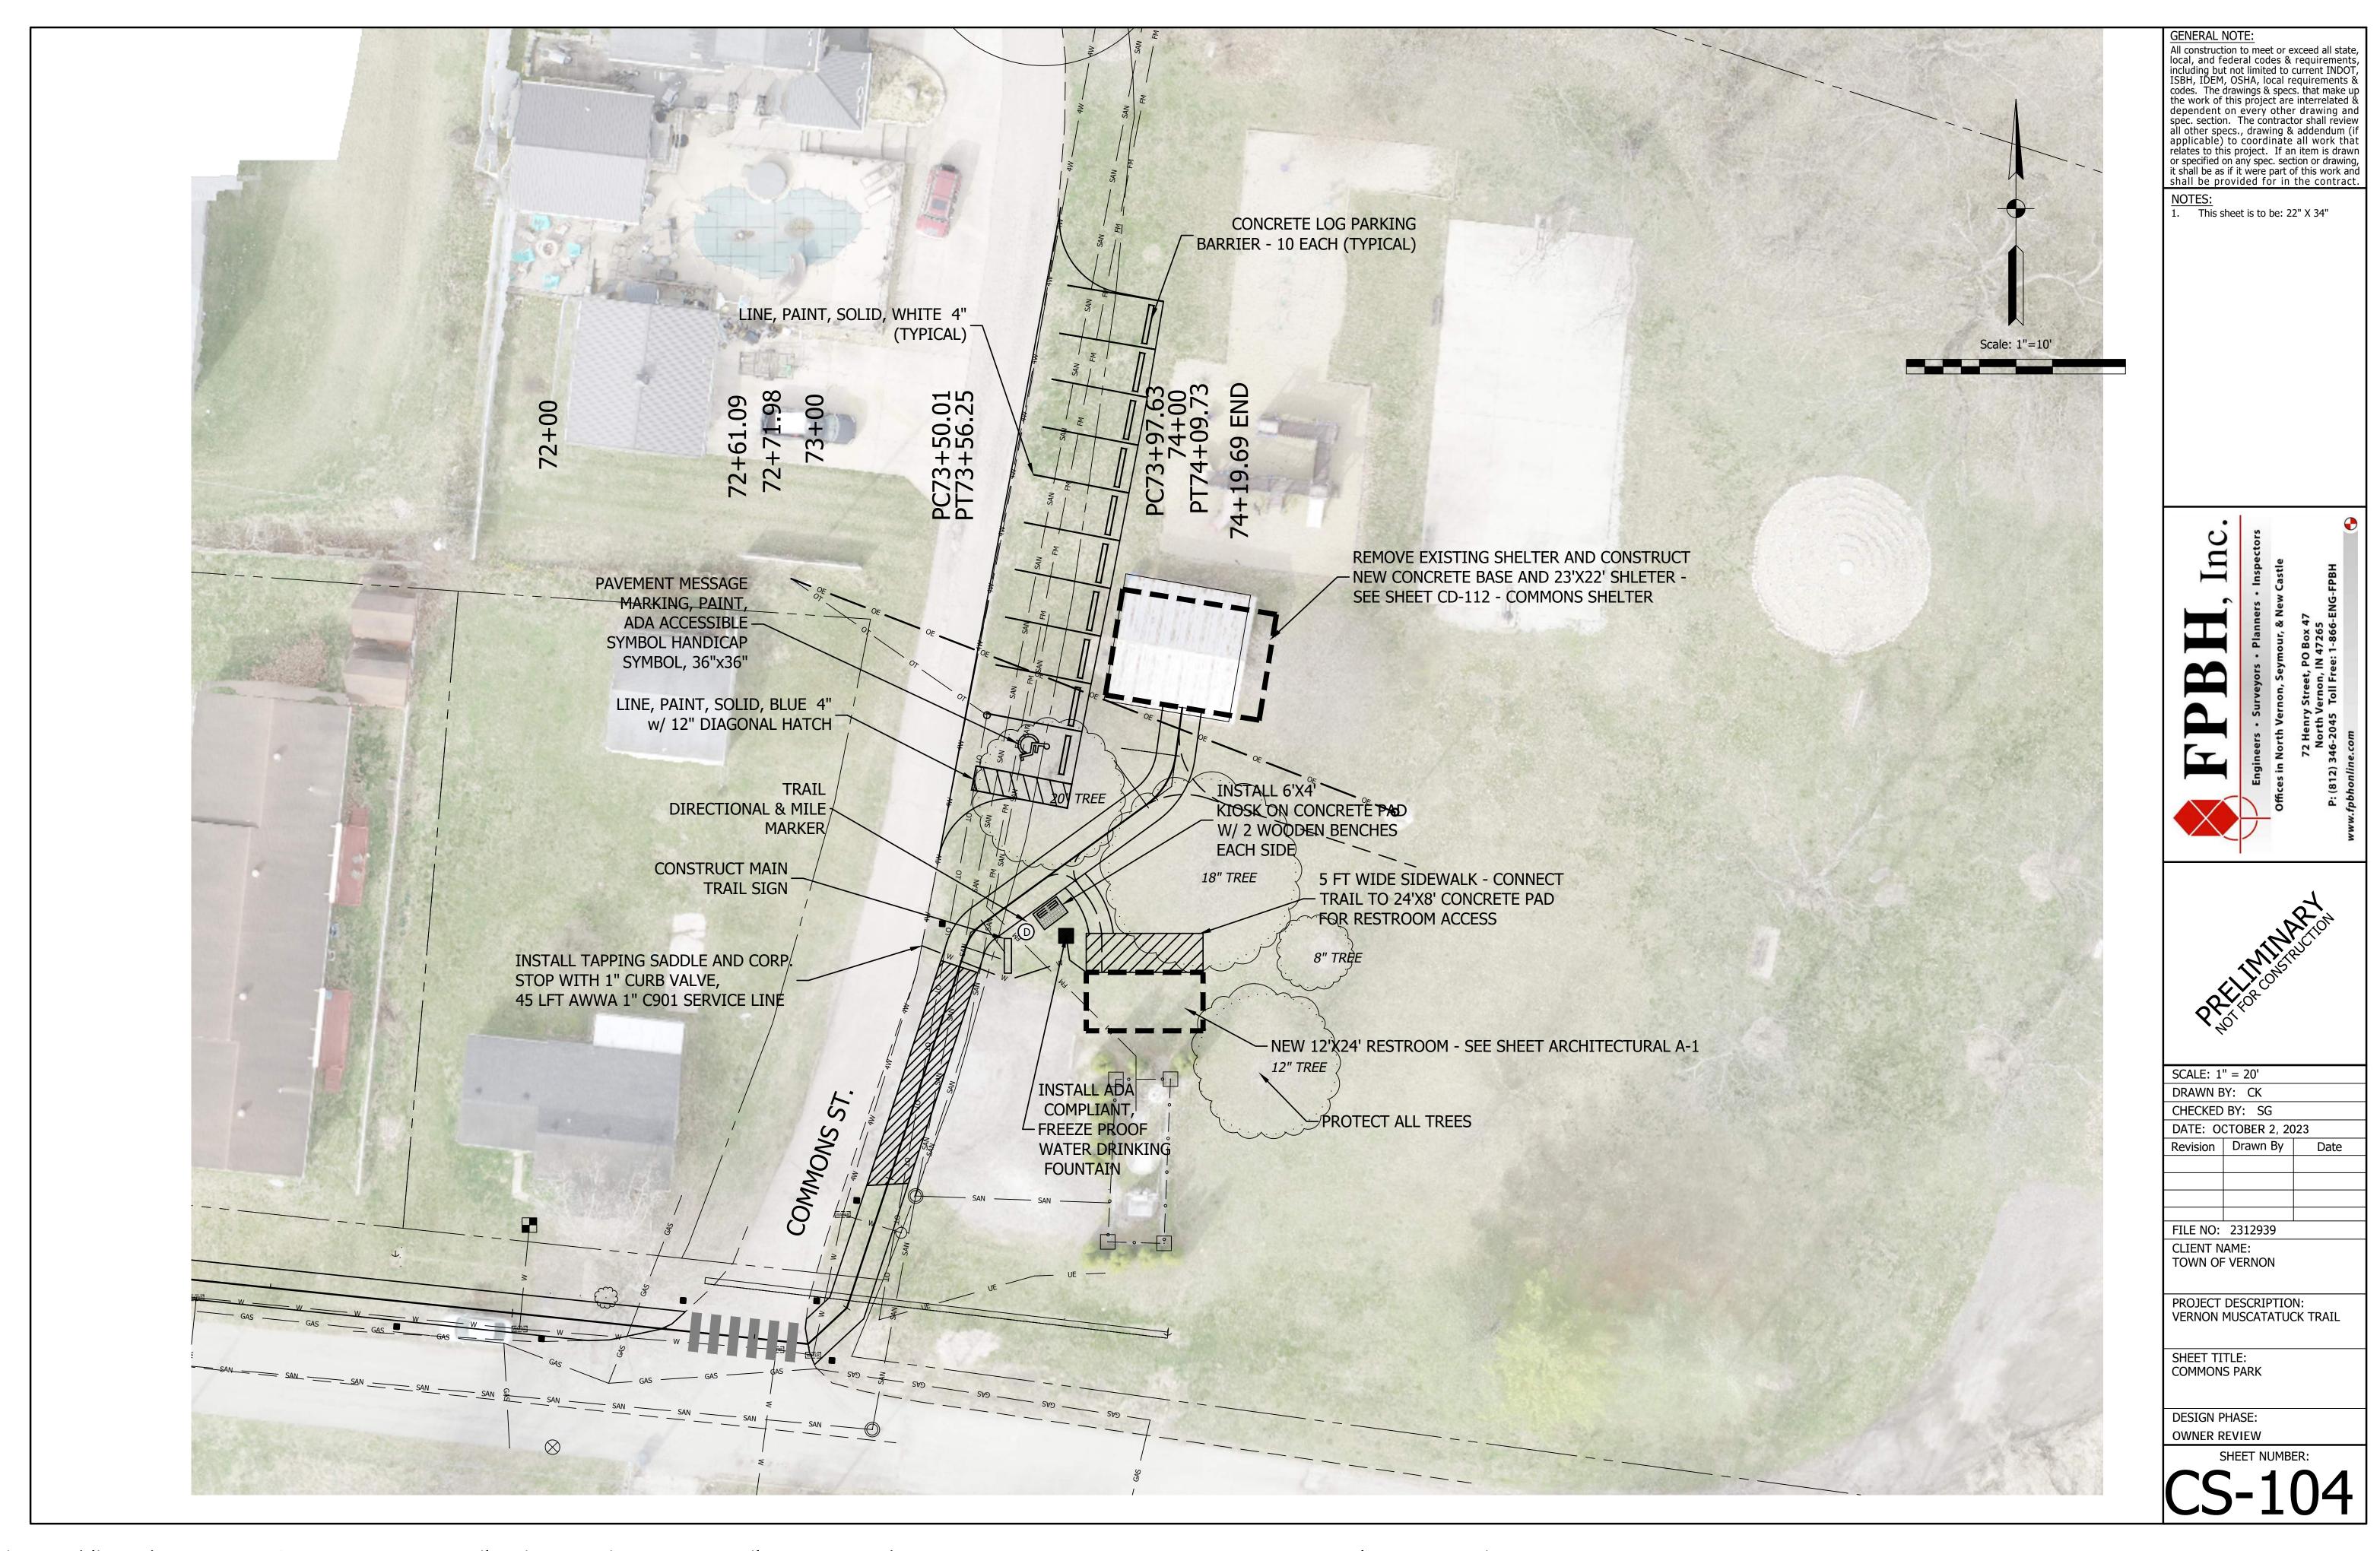


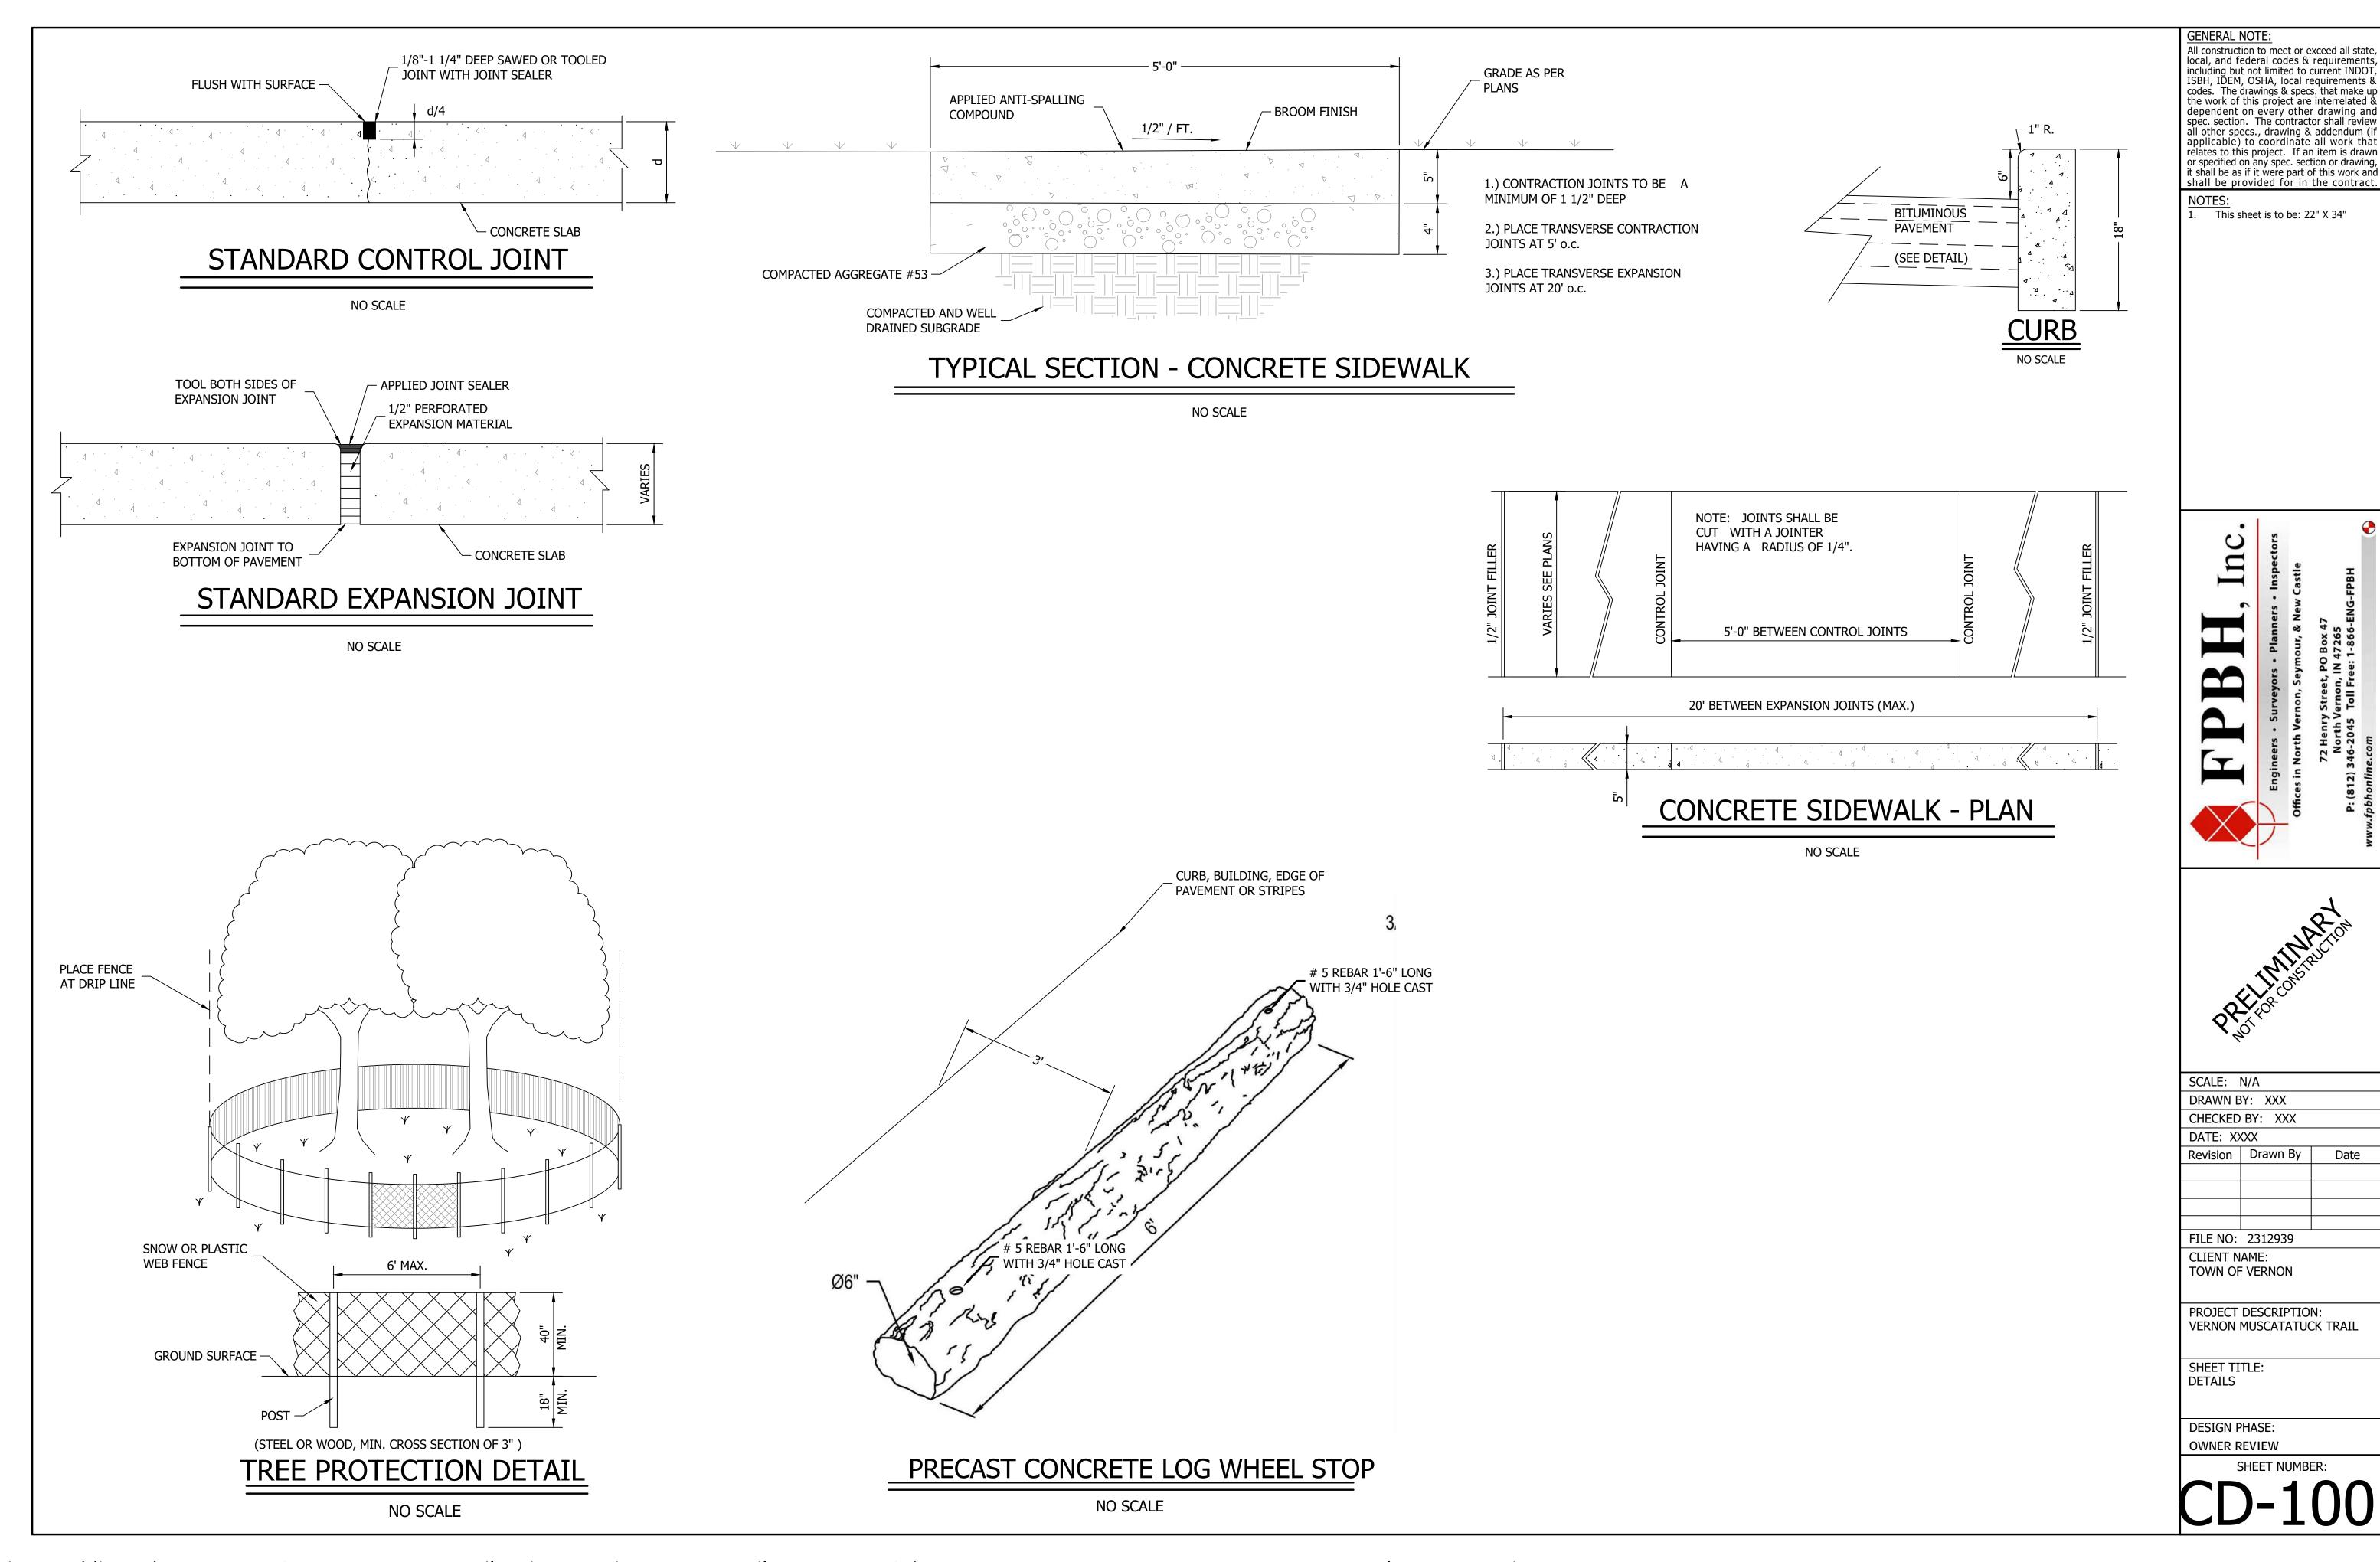

# CONCRETE MASONRY UNIT RETAINING WALL

		LE	VELING COUR	SE		FOOT	TING			CMU WALL									
CLEAR WIDTH	GEOTEXTILE TYPE	TYPE	DEPTH	WIDTH	TYPE	DEPTH	WIDTH	REINFORC.	WIDTH	HEIGHT	EMBEDMENT DEPTH	REINFORC.	WIRE MESH LADDER	END TYPE	FACE ROCK	MORTAR TYPE	SHEET DRAIN	COLLECTOR PIPE	COMMENTS
	G	L			FT														
		WIDTH TYPE	CLEAR GEOTEXTILE TYPE	CLEAR GEOTEXTILE TYPE DEPTH	WIDTH TYPE DEPTH WIDTH	CLEAR GEOTEXTILE TYPE DEPTH WIDTH TYPE	CLEAR GEOTEXTILE TYPE DEPTH WIDTH TYPE DEPTH	CLEAR GEOTEXTILE TYPE DEPTH WIDTH TYPE DEPTH WIDTH	CLEAR GEOTEXTILE TYPE DEPTH WIDTH TYPE DEPTH WIDTH REINFORC.	CLEAR GEOTEXTILE TYPE DEPTH WIDTH TYPE DEPTH WIDTH REINFORC. WIDTH	CLEAR GEOTEXTILE TYPE DEPTH WIDTH TYPE DEPTH WIDTH REINFORC. WIDTH HEIGHT	CLEAR GEOTEXTILE TYPE DEPTH WIDTH TYPE DEPTH WIDTH REINFORC. WIDTH HEIGHT EMBEDMENT DEPTH	CLEAR GEOTEXTILE TYPE DEPTH WIDTH TYPE DEPTH WIDTH REINFORC. WIDTH HEIGHT EMBEDMENT DEPTH REINFORC.	CLEAR GEOTEXTILE TYPE DEPTH WIDTH TYPE DEPTH WIDTH REINFORC. WIDTH HEIGHT EMBEDMENT DEPTH REINFORC. WIDTH HEIGHT DEPTH REINFORC. WIDTH HEIGHT DEPTH REINFORC. WIDTH LADDER	CLEAR GEOTEXTILE TYPE DEPTH WIDTH TYPE DEPTH WIDTH REINFORC. WIDTH HEIGHT EMBEDMENT DEPTH REINFORC. WIDTH HEIGHT EMBEDMENT DEPTH REINFORC. WIDTH REINFORC. WIDTH HEIGHT DEPTH REINFORC. WIDTH HEIGHT DEPTH REINFORC. WIDTH REINFORC. WIDTH HEIGHT DEPTH DEPTH HEIGHT DEPTH DEPTH HEIGHT DEPTH	CLEAR WIDTH TYPE DEPTH WIDTH TYPE DEPTH WIDTH REINFORC. WIDTH HEIGHT EMBEDMENT DEPTH REINFORC. WIRE MESH LADDER FACE ROCK	CLEAR GEOTEXTILE TYPE DEPTH WIDTH TYPE DEPTH WIDTH REINFORC. WIDTH HEIGHT EMBEDMENT DEPTH REINFORC. WIDTH HEIGHT EMBEDMENT DEPTH REINFORC. WIDTH HEIGHT EMBEDMENT DEPTH REINFORC. WIDTH R	CLEAR GEOTEXTILE TYPE DEPTH WIDTH TYPE DEPTH WIDTH REINFORC. WIDTH HEIGHT EMBEDMENT DEPTH REINFORC. WIDTH HEIGHT EMBEDMENT DEPTH REINFORC. WIDTH HEIGHT EMBEDMENT DEPTH REINFORC. WIRE MESH LADDER FACE ROCK TYPE DRAIN	CLEAR GEOTEXTILE TYPE DEPTH WIDTH TYPE DEPTH WIDTH REINFORC. WIDTH HEIGHT EMBEDMENT DEPTH REINFORC. WIDTH HEIGHT EMBEDMENT DEPTH REINFORC. WIDTH HEIGHT EMBEDMENT DEPTH REINFORC. WIDTH REINFORC. WIDTH HEIGHT EMBEDMENT DEPTH REINFORC. WIDTH

LEVELING COURSE MATERIAL

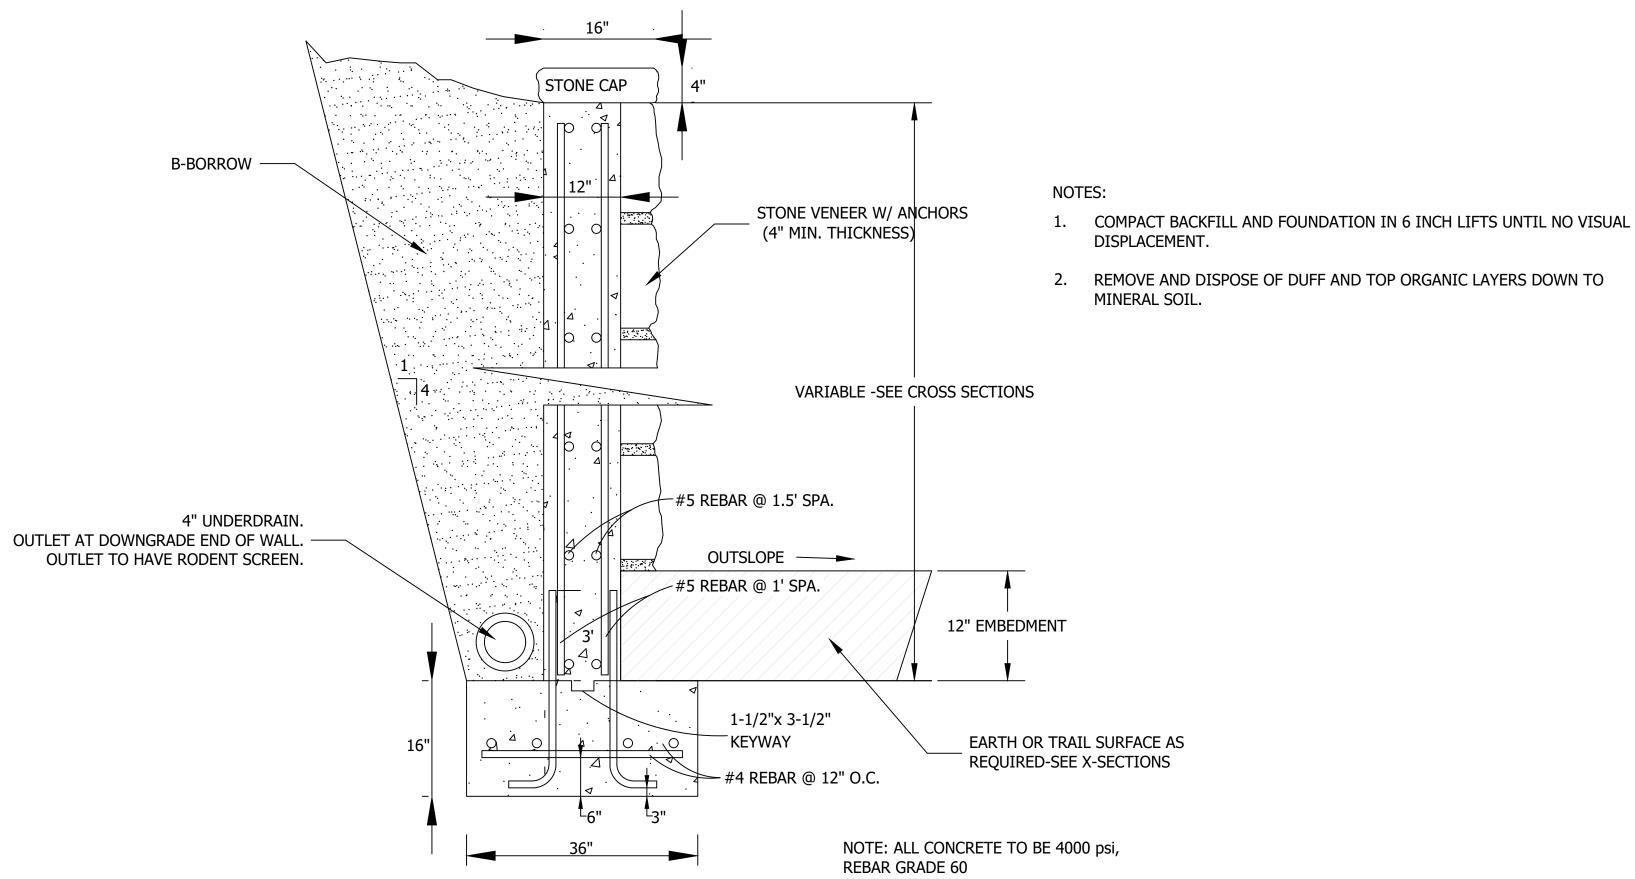



# GEOTEXTILE TYPE

GEOTEXTILE	GEOTEXTILE	COMMENTS						
TYPE	MATERIAL	COMMENTS	TYPE	   MATERIAL	GRADATION			
G1	NON-WOVEN		1112	MATERIAL	GIVADATION			
G2	WOVEN		L1	PITRUN				
G3	GEOGRID		L2	AGGREGATE				
G4			L3					
				•	•			

- REMOVE AND DISPOSE OF DUFF AND TOP ORGANIC LAYERS DOWN TO

FOOTING MATERIAL


MATERIAL	GRADATION	COMMENTS	TYPE	MATERIAL	GRADATION	COMMENTS
PITRUN			FT1	CONCRETE		
AGGREGATE			FT2	AGGREGATE		
			FT3			
				•		

## GENERAL NOTE:

All construction to meet or exceed all state, local, and federal codes & requirements, including but not limited to current INDOT, ISBH, IDEM, OSHA, local requirements & codes. The drawings & specs. that make up the work of this project are interrelated & dependent on every other drawing and spec. section. The contractor shall review all other specs., drawing & addendum (if applicable) to coordinate all work that relates to this project. If an item is drawn or specified on any spec. section or drawing, it shall be as if it were part of this work and shall be provided for in the contract.

1. This sheet is to be: 22" X 34"



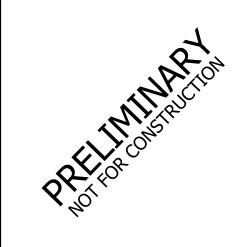

SCALE: 1" = 20'									
DRAWN BY: CK									
CHECKED	BY: SG								
DATE: O	CTOBER 2, 20	)23							
Revision	Drawn By	Date							

FILE NO: 2312939 CLIENT NAME: TOWN OF VERNON

PROJECT DESCRIPTION: VERNON MUSCATATUCK TRAIL


SHEET TITLE: CONCRETE MASONRY UNIT RETAINING WALL

DESIGN PHASE:

# STANDARD FOOTBRIDGE

			FOOTING MATERIAL			MATERIAL POST/SILLS/BACKWALLS			HEADER BEAM/STRINGERS/					
TYPICAL ID	SECTION TYPE	OVERALL WIDTH	SURFACE WIDTH	TYPE	DEPTH	WIDTH	POST HEIGHT	POST EMBEDMENT DEPTH	SPECIES	PRESERV. TYPE	DECK/CI DECK SIZE	SPECIES	SYSTEM PRESERV. TYPE	COMMENTS
	N/A	4'-9"	Χ	F 1	5.5'	18"	9.75'	5.5'	Χ	P 3	3x8	Χ	P 3	X

N/A WHEN NOT APPLICABLE

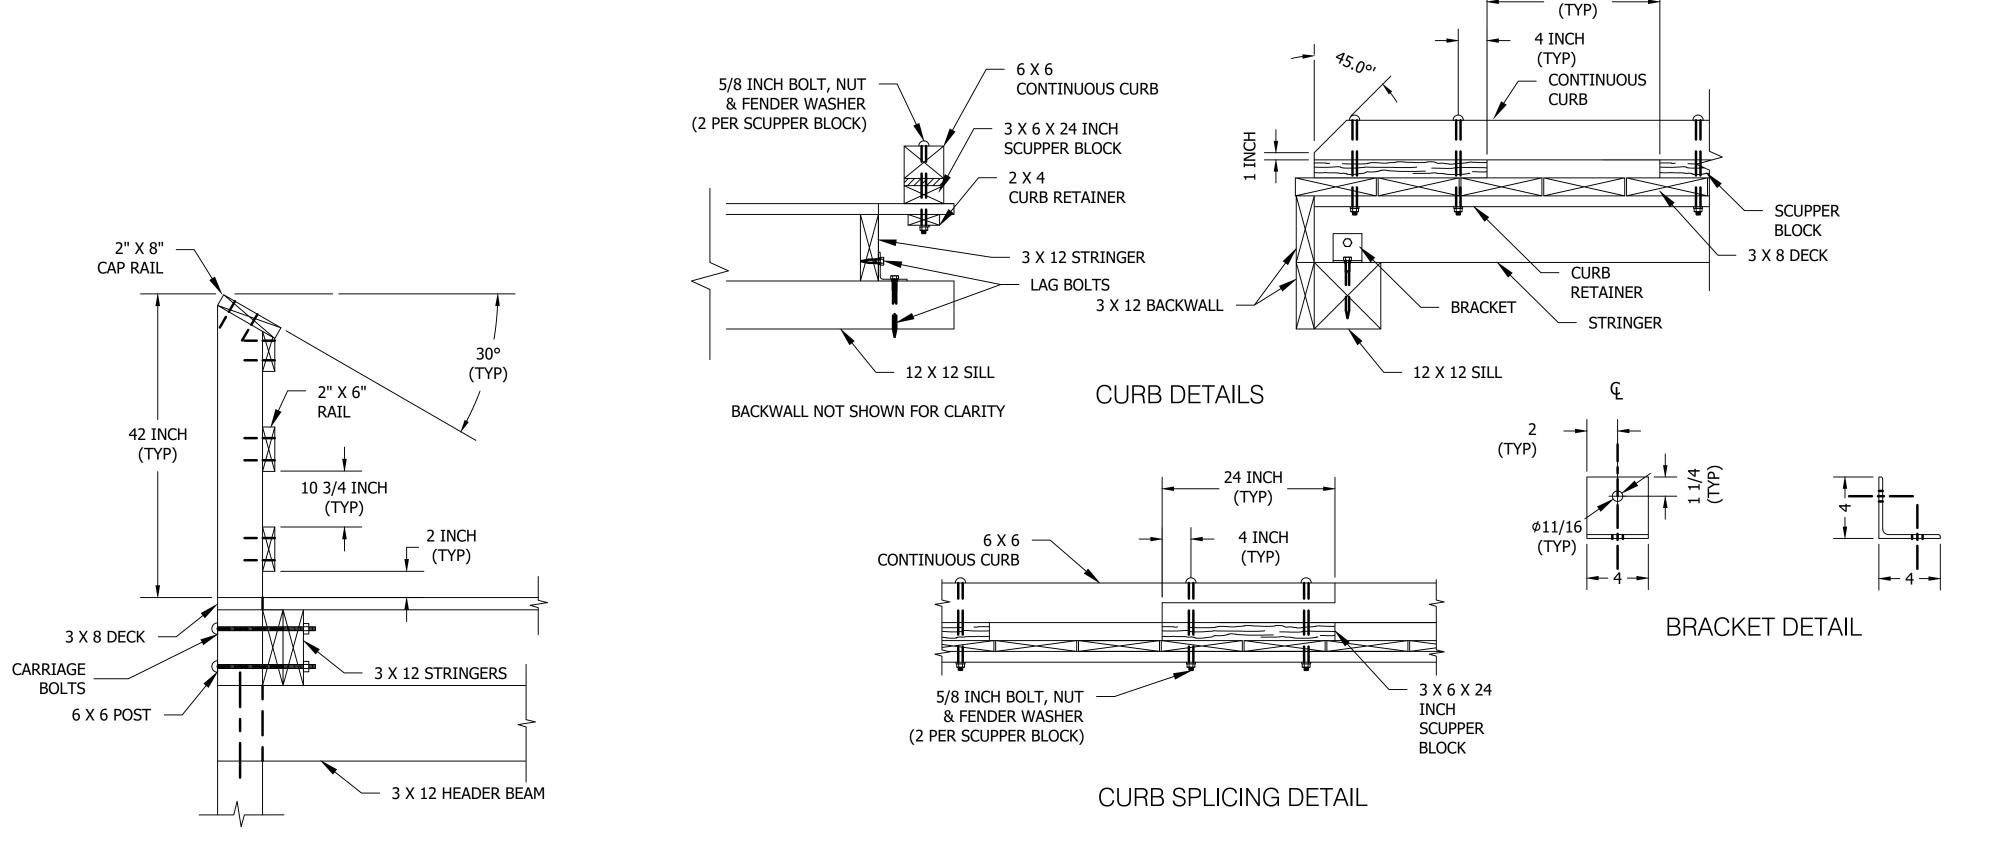

FOOT BRIDGE DETAILS

## NOTES:

- 1. DESIGN LOAD: 100 PSF PEDESTRIAN LOAD.
- 2. ALL MATERIAL TYPE SHALL BE DOUGLAS FIR OR SOUTHERN PINE NO. 2 OR BETTER AS SPECIFIED IN THE ABOVE TABLE.
- 3. ALL FASTENERS SHALL BE GALVANIZED.
- 4. FASTENERS:
- **DECKING:**
- 60d 6 INCH RING SHANK NAILS OR DECK SCREWS 2 PER DECK
- STRINGER CONNECTION.

### RAILING:

- NO. 10 X 4 INCH LONG WOOD
- SCREWS 2 PER RAIL POST CONNECTION.

# STRINGERS &

- **BACKWALLS:**
- 40d 5 INCH LONG RING SHANKNAILS.
- 5. ALERNATIVE FOR 7/8 BOLTS FOR HEADER BEAM IS BRACKET WITH AN ALLOWABLE LOAD OF 1100 LBS EACH SIDE.


**M** 

GENERAL NOTE:

All construction to meet or exceed all state, local, and federal codes & requirements,

including but not limited to current INDOT ISBH, IDEM, OSHA, local requirements & codes. The drawings & specs. that make up the work of this project are interrelated 8 dependent on every other drawing and spec. section. The contractor shall review all other specs., drawing & addendum (if applicable) to coordinate all work that relates to this project. If an item is drawn or specified on any spec. section or drawing it shall be as if it were part of this work and shall be provided for in the contract.

1. This sheet is to be: 22" X 34"

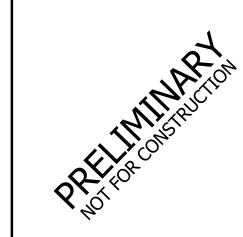

SCALE: NTS								
DRAWN BY: XXX								
CHECKED BY: XXX								
DATE: XXX								
Revision	Drawn By	Date						
FILE NO:	2312939							
	DRAWN E CHECKED DATE: XX Revision	DRAWN BY: XXX CHECKED BY: XXX DATE: XXX						

CLIENT NAME: TOWN OF VERNON

PROJECT DESCRIPTION: VERNON MUSCATATUCK TRAIL

SHEET TITLE: STD\_938-10-01 STANDARD BOARDWALK

DESIGN PHASE: OWNER REVIEW

# FOOTING MATERIAL

RAIL SYSTEM DETAIL

TYPE	MATERIAL	GRADATION	COMMENTS
FT1	CONCRETE	N/A	4000 psi

PRESERVATIVE TREATMENT - (REFER TO AWPA USE CATEGORY SYSTEM)  PRESERVATIVE TREATMENT USE  COMMENTS							
TYPE	TYPE	CATEGORY	COMMENTS				
P1	OT	UC4A					
P2	OT	UC3B					
P3 OT		UC4B	Х				
TREATME	ENT TYPE		USE CATEGORY	SHEET 1 OF 3			

TREATMENT TYPE

24 INCH

WB = WATERBORNE OT = OIL-BORNE


UC3B = ABOVE GROUND


UC4A = GROUND CONTACT UC4B = GROUND CONTACT - HEAVY DUTY

**EXPOSED** 


GENERAL USE

N:\Projects\PublicWorks\Vernon\2312939\_Vernon\_NLTTrailDesign\Drawings\VernonTrail\_DETAILS\_No1.dwg, 9/28/2023 8:46:00 AM, \_AutoCAD PDF (General Documentation).pc3

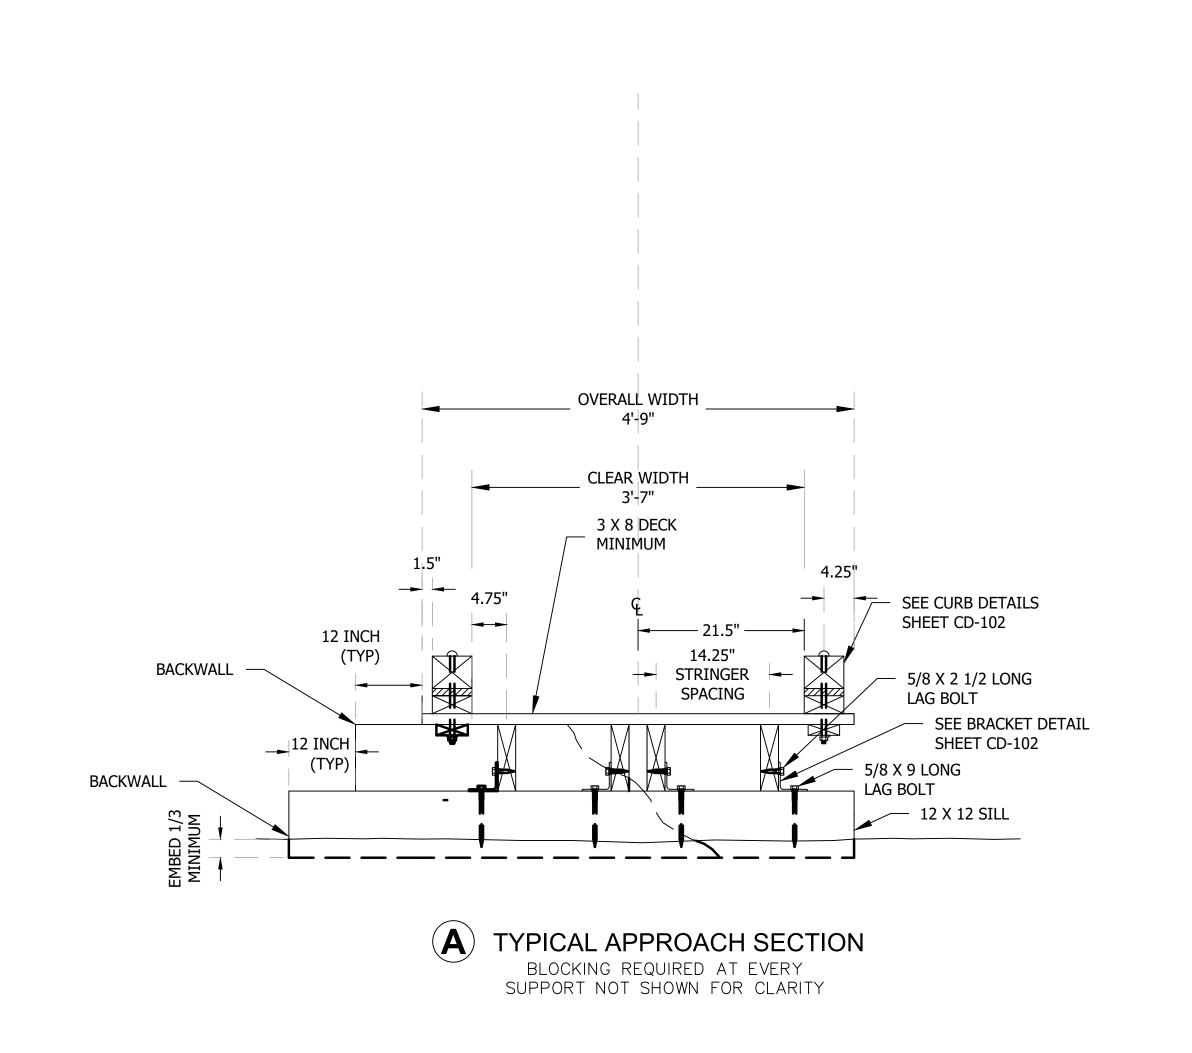

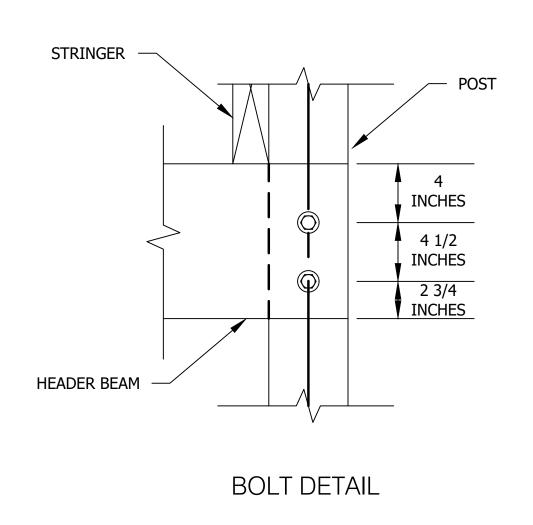



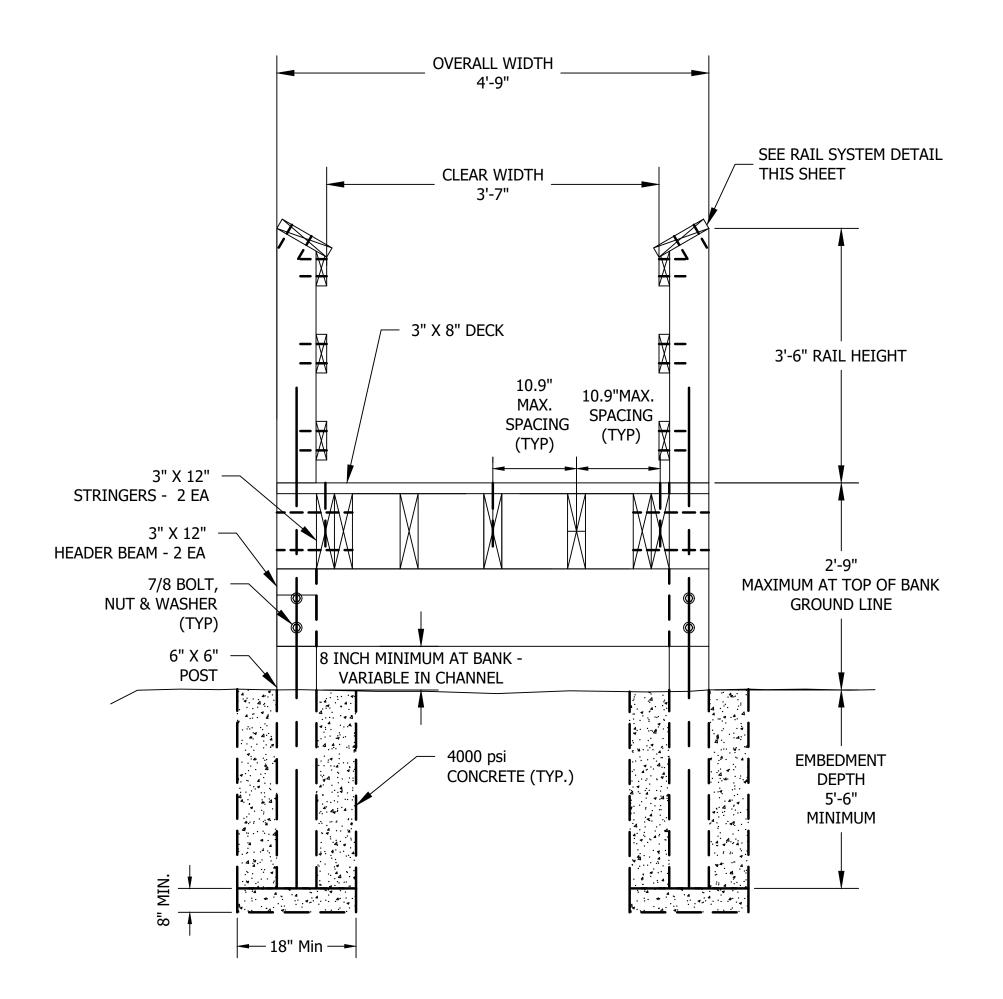

# B TYPICAL BRIDGE DECK SECTION

LESS THAN 3 FEET WITH CURB BLOCKING REQUIRED AT EVERY SUPPORT NOT SHOWN FOR CLARITY GENERAL NOTE:

All construction to meet or exceed all state, local, and federal codes & requirements, including but not limited to current INDOT, ISBH, IDEM, OSHA, local requirements & codes. The drawings & specs. that make up the work of this project are interrelated & dependent on every other drawing and spec. section. The contractor shall review all other specs., drawing & addendum (if applicable) to coordinate all work that relates to this project. If an item is drawn or specified on any spec. section or drawing, it shall be as if it were part of this work and shall be provided for in the contract.

NOTES:

1. This sheet is to be: 22" X 34"





SCALE:	NTS							
DRAWN BY: XXX								
CHECKED BY: XXX								
DATE: XXX								
Revision	Drawn By	Date						
ETLE NO.	2212020							
FILE NO:	2312939							
CLIENT N	AME:							

TOWN OF VERNON

PROJECT DESCRIPTION: VERNON MUSCATATUCK TRAIL


SHEET TITLE: STD\_938-10-02 STANDARD BOARDWALK

DESIGN PHASE:


WNER REVIEW

SHEET 2 OF 3

<u>CD-103</u>

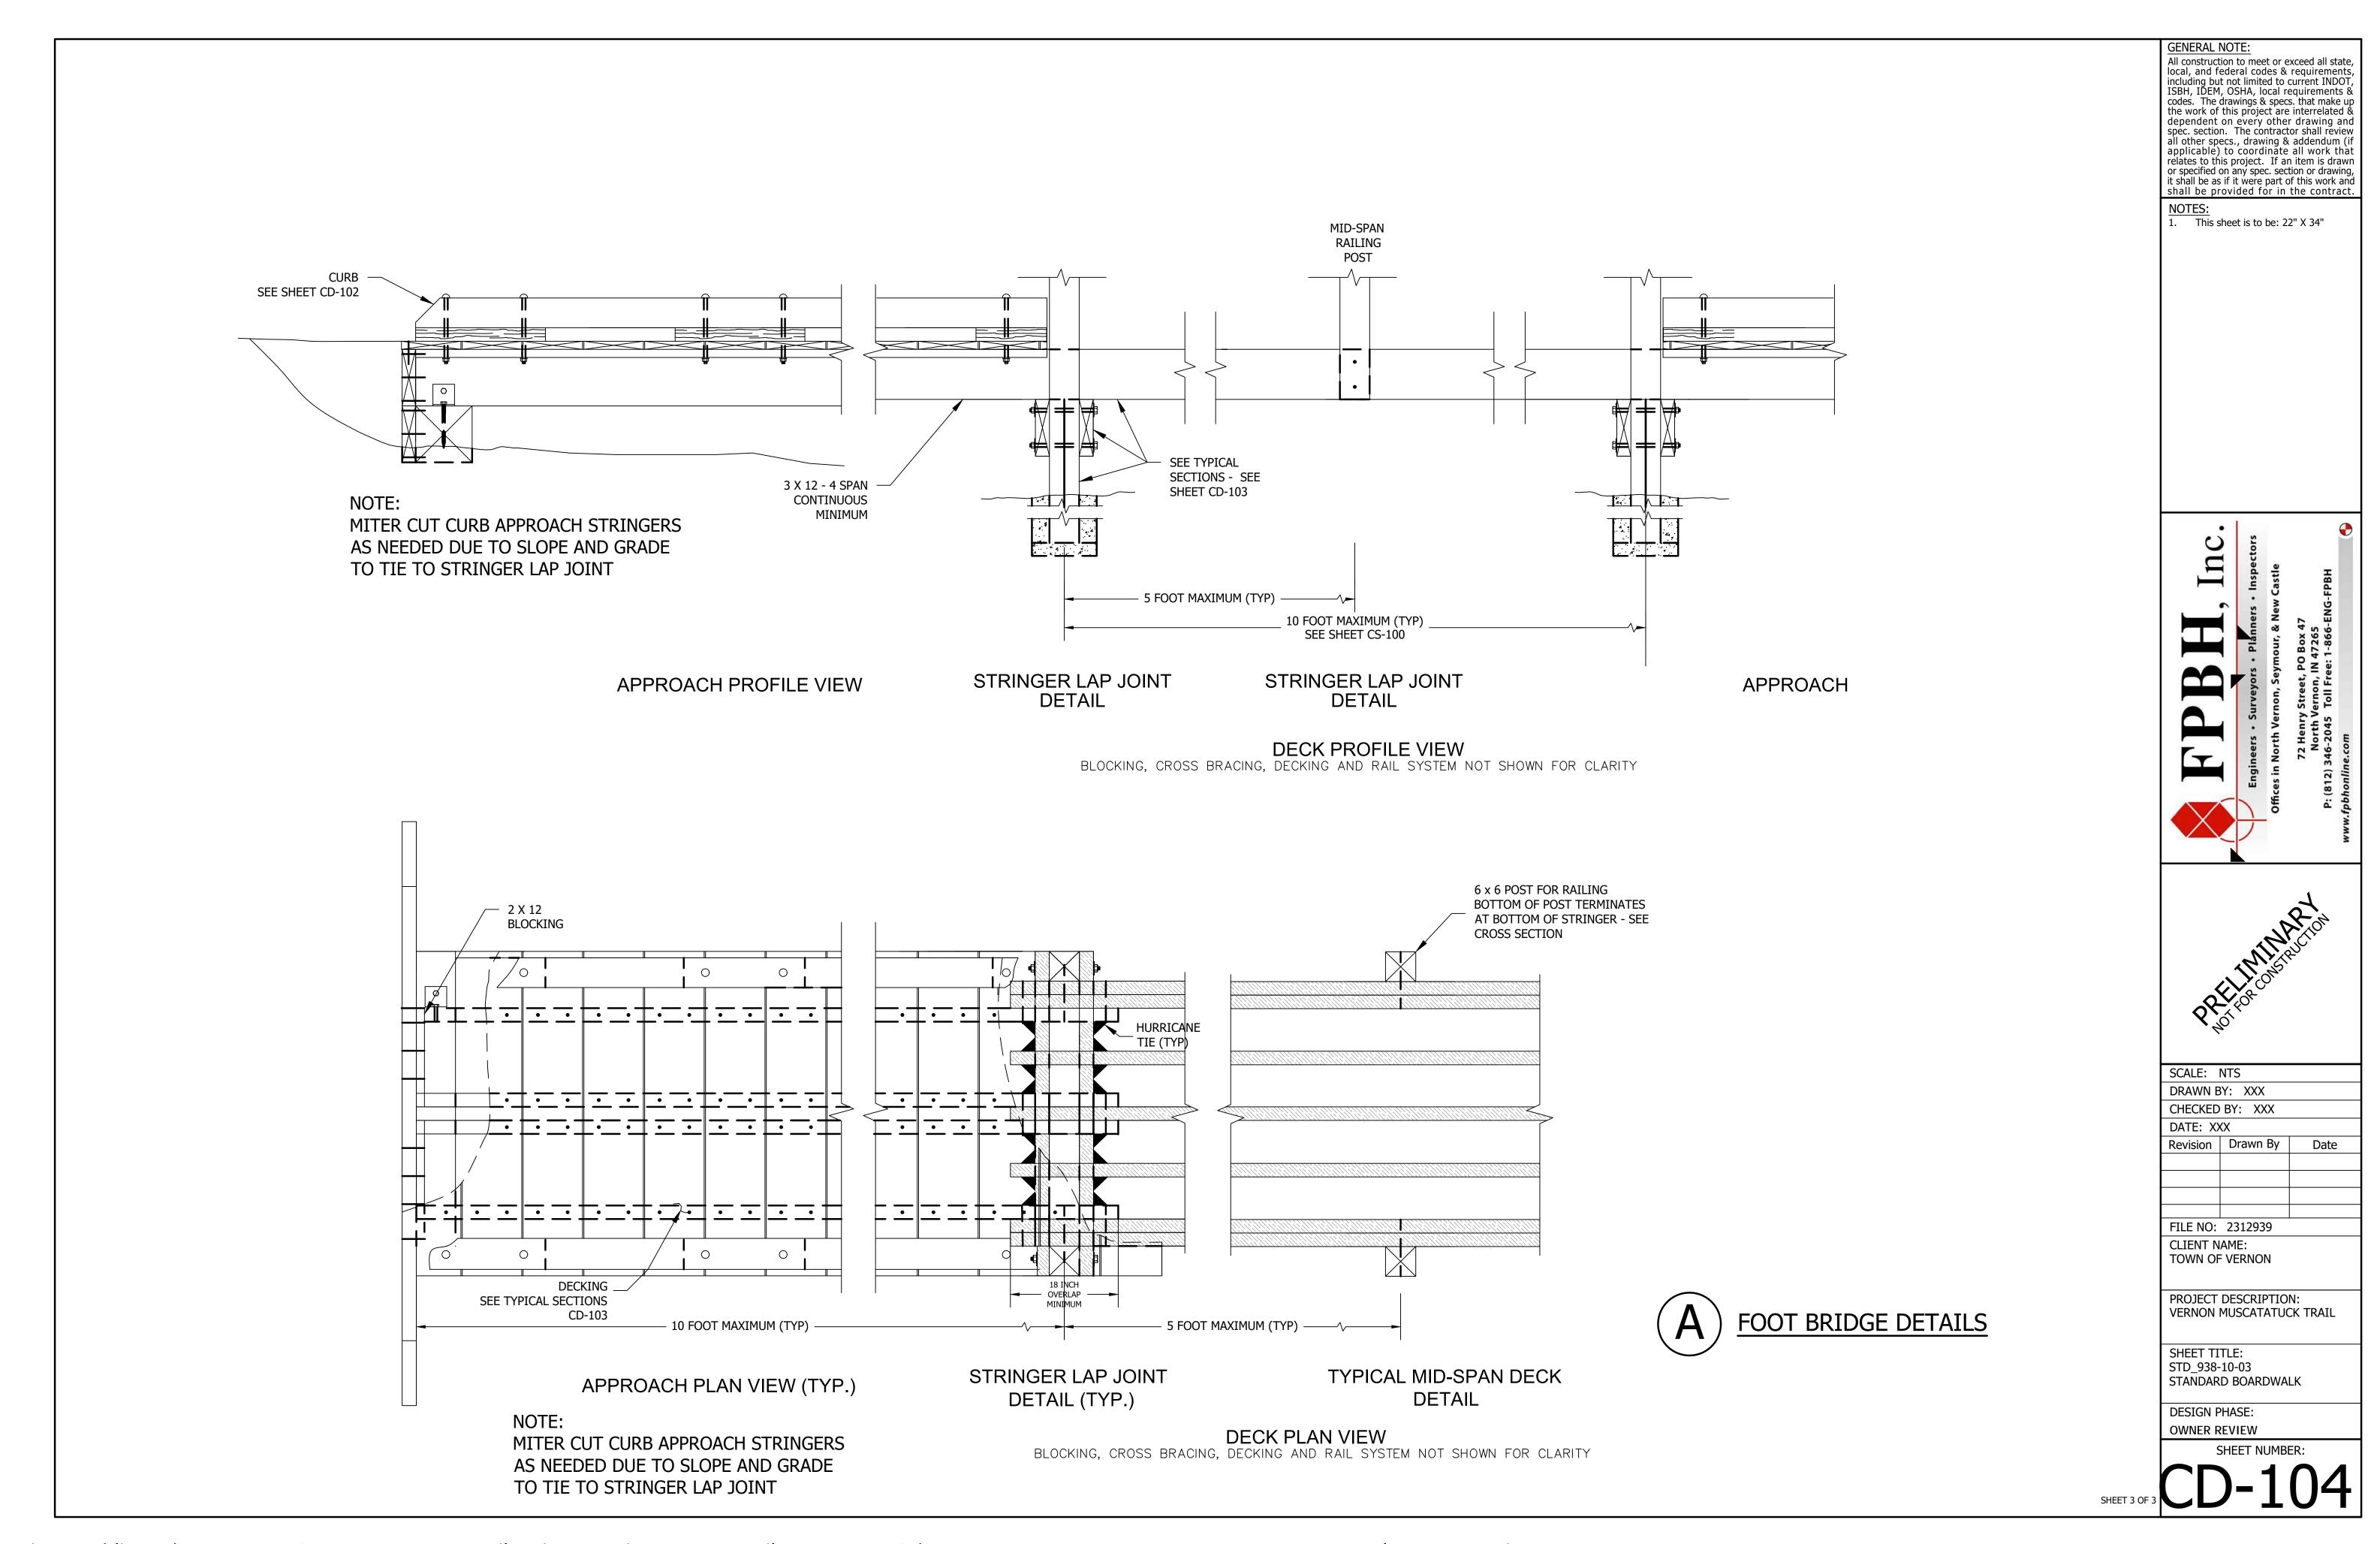


# SILL CARRIAGE **EMBED** 6 INCH MINIMUM

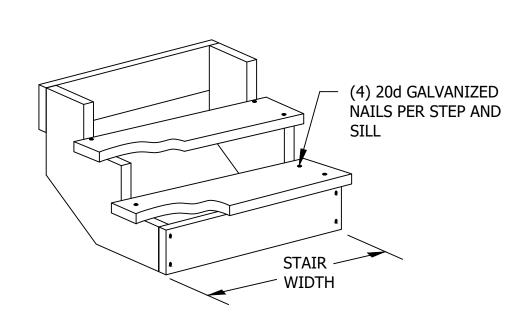

TWO CARRIAGE OPTION

FOR 3 FOOT OR LESS STEP WIDTH

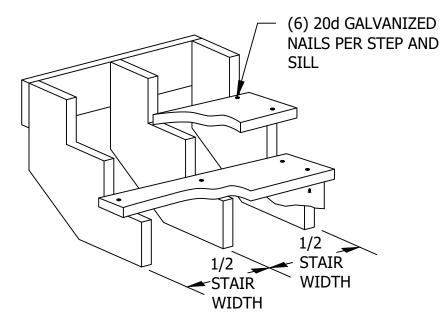


THREE CARRIAGE OPTION

FOR 3 TO 6 FOOT STEP WIDTH


# STAIRCASE

		CARR	RIAGE	SILL		STI	EP				
TYPICAL ID	SPAN	NO. OF CARRIAGES	MATERIAL DIMENSION	MATERIAL DIMENSION	WIDTH	MATERIAL DIMENSION	RUN	RISE	SPECIES	PRESERV. TYPE	COMMENTS
	Х	Х	XxX	XXX	X	XxX	X	X	Х	PΧ	X
					-						

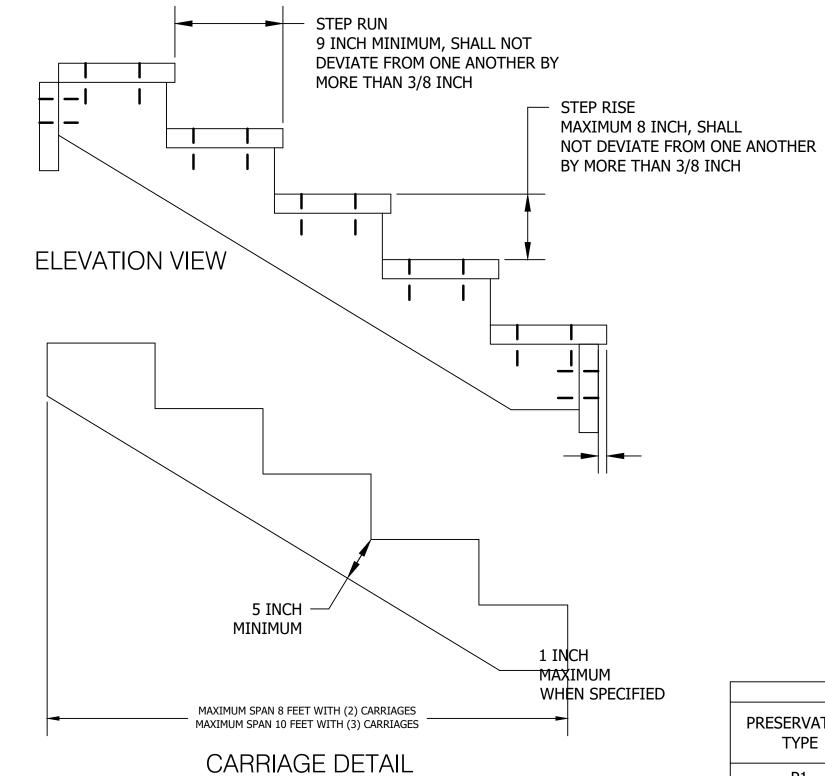

# NOTES:

- 1. COMPACT BACKFILL IN 6 INCH LIFTS UNTIL NO VISUAL DISPLACEMENT.
- REMOVE AND DISPOSE OF DUFF AND TOP ORGANIC LAYERS
- 2. DOWN TO MINERAL SOIL.

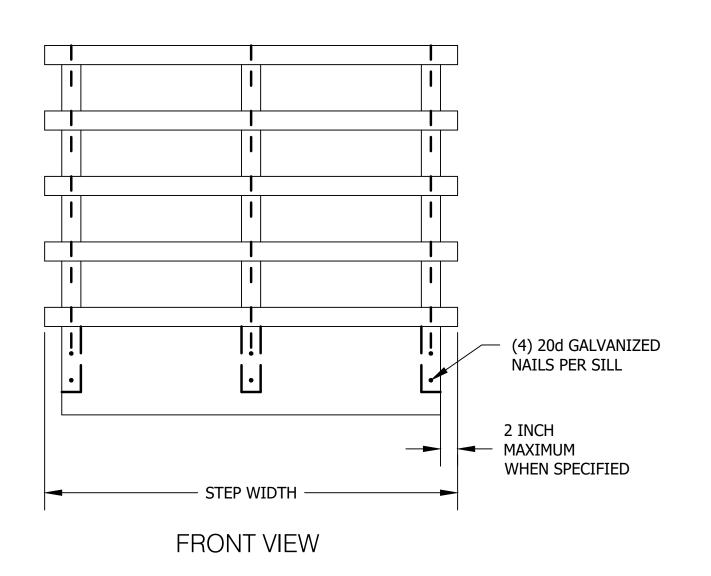

PRESERVATIVE TREATMENT - (REFER TO AWPA USE CATEGORY SYSTEM)										
PRESERVATIVE TYPE	TREATMENT TYPE	USE CATEGORY	COMMENTS							
P1	WB	UC4A	X							
P2	WB	UC3B								
P3	XX	XXXX								

TREATMENT TYPE

WB = WATERBORNE OT = OIL-BORNE

**USE CATEGORY** UC3B = ABOVE GROUND

- EXPOSED - GENERAL USE = GROUND CONTACT = GROUND CONTACT - HEAVY DUTY

GENERAL NOTE:

All construction to meet or exceed all state, local, and federal codes & requirements, including but not limited to current INDOT, ISBH, IDEM, OSHA, local requirements & codes. The drawings & specs, that make up the work of this project are interrelated by the work of this project are interrelated & dependent on every other drawing and spec. section. The contractor shall review all other specs., drawing & addendum (if applicable) to coordinate all work that relates to this project. If an item is drawn or specified on any spec. section or drawing, it shall be as if it were part of this work and shall be provided for in the contract.

1. This sheet is to be: 22" X 34"




SCALE:	NTS						
DRAWN BY: XXX							
CHECKED	BY: XXX						
DATE: X	(X						
Revision	Drawn By	Date					
FILE NO:	2312939						

CLIENT NAME: TOWN OF VERNON

PROJECT DESCRIPTION: VERNON MUSCATATUCK TRAIL

SHEET TITLE: STD\_936-40-01 STAIRCASE


**DESIGN PHASE:** OWNER REVIEW

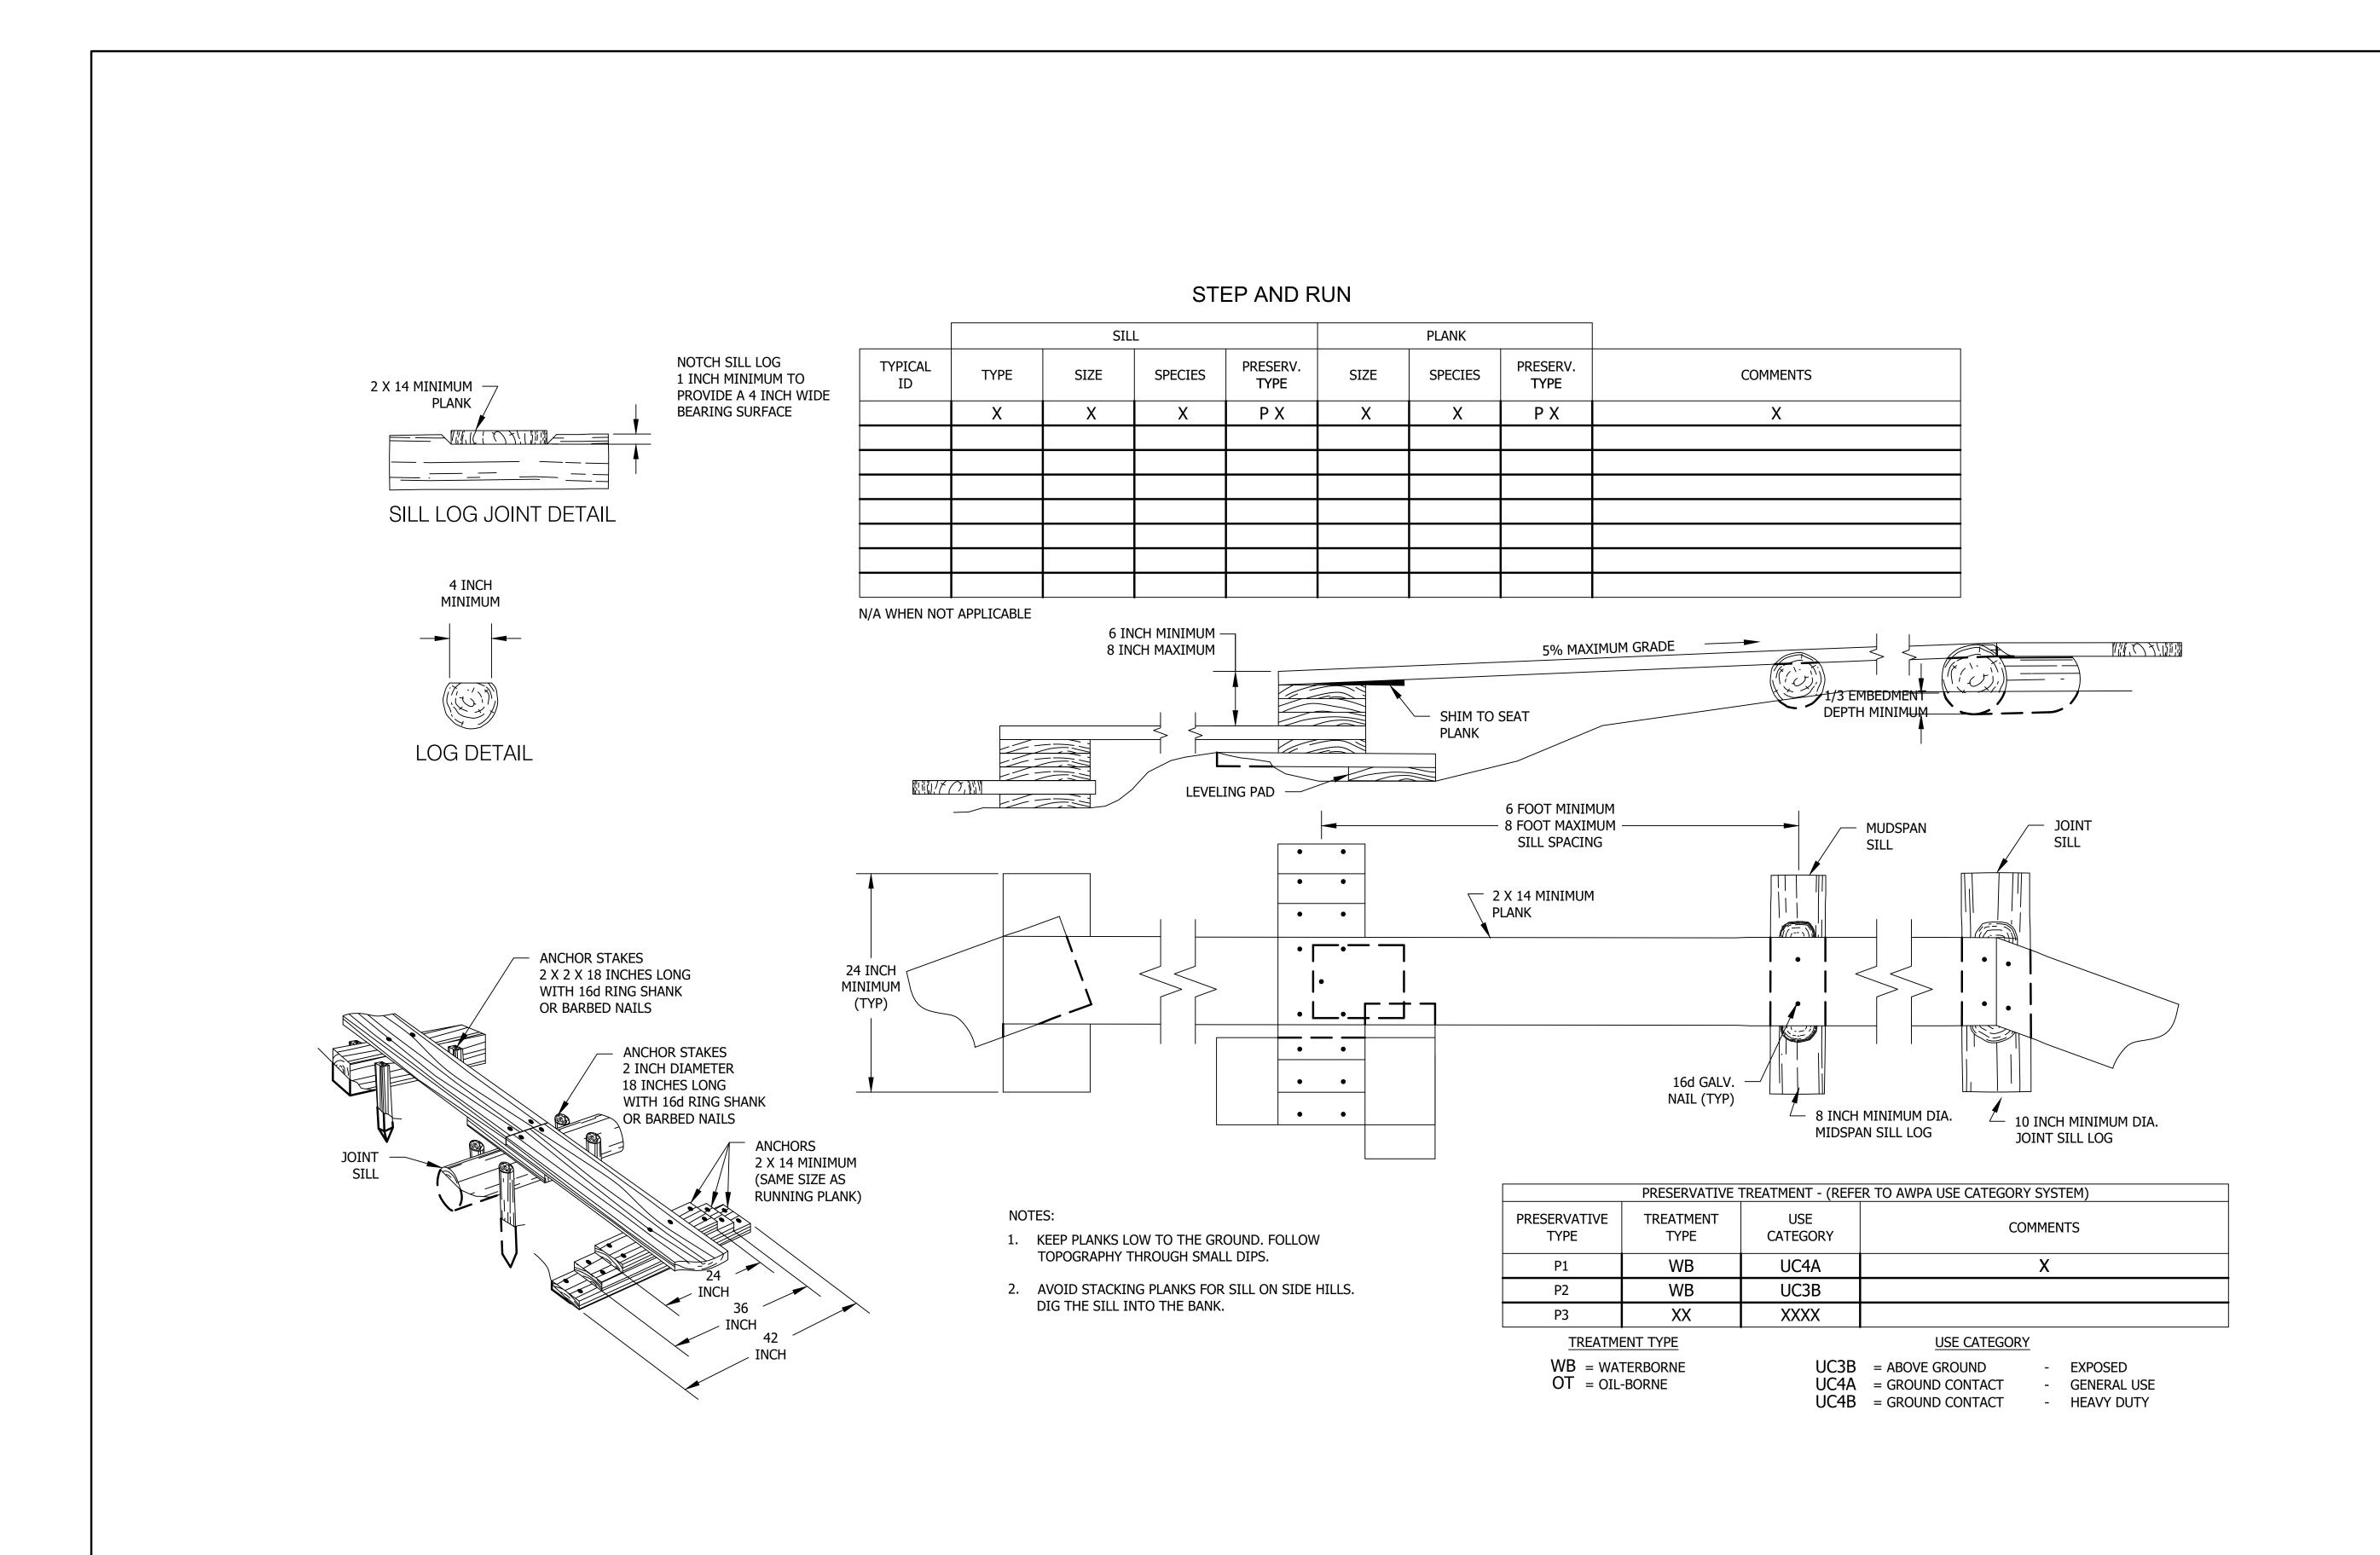

All construction to meet or exceed all state, local, and federal codes & requirements, including but not limited to current INDOT ISBH, IDEM, OSHA, local requirements & codes. The drawings & specs, that make up the work of this project are interrelated & dependent on every other drawing and spec. section. The contractor shall review all other specs., drawing & addendum (if applicable) to coordinate all work that relates to this project. If an item is drawn or specified on any spec. section or drawing, it shall be as if it were part of this work and shall be provided for in the contract.

1. This sheet is to be: 22" X 34"



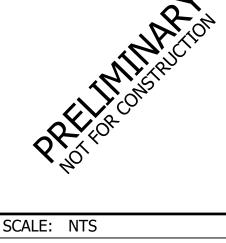

	SCALE: NTS DRAWN BY: XXX							
	CHECKED BY: XXX							
	DATE: X	(X						
	Revision	Drawn By	Date					
	ETLE NO.	2212020						
		2312939						
	L CLIENT N	AMF:						

CLIENT NAME: TOWN OF VERNON

PROJECT DESCRIPTION: VERNON MUSCATATUCK TRAIL

SHEET TITLE: STD\_938-30-01

STEP AND RUN **DESIGN PHASE:** 

OWNER REVIEW

# BOLLARDS

		BOLLARD					
TYPICAL ID	SECTION TYPE	TYPE	SIZE	HEIGHT	EMBEDMENT DEPTH	PRESERV. TYPE	COMMENTS
	N/A	BD 4	8 x 8	36"	36"	P 3	PROVIDE WHITE REFLECTORIZED STRIP
	N/A	BD 4	8 x 8	36"	N/A	P 3	PROVIDE WHITE REFLECTORIZED STRIP
							SIGN LEGEND "NO MOTOR VEHICLES" FACING ROAD SIDE
							SIGN LEGEND "STOP" FACING TRIAL SIDE



# A PERMANENT INSTALLATION SECTION

SHALL BE 2X BOLLARD WIDTH (TYP)

# REMOVABLE INSTALLATION SECTION SINGLE LOCK SYSTEM SHOWN

# **BOLLARD MATERIAL**

TYPE	MATERIAL	COMMENTS
BD1	LOG	
BD2	STEEL	
BD3	CONCRETE	
BD4	TIMBER	
BD5	RAILROAD TIE	
BD6	MANUFACTURED	
BD7		

# NOTES:

- REMOVE AND DISPOSE OF DUFF AND TOP ORGANIC LAYERS DOWN TO MINERAL SOIL.
- 2. COMPACT BACKFILL IN 6 INCH LIFTS UNTIL NO VISUAL DISPLACEMENT.
- 3. WHEN SPECIFIED INSTALL PER MANUFACTURERS INSTRUCTION.
- 4. OBJECT MARKERS REQUIRED ON MOTORIZED TRAILS.

	PRESERVATIVE TREATMENT - (REFER TO AWPA USE CATEGORY SYSTEM)										
PRESERVATIVE TYPE	TREATMENT TYPE	USE CATEGORY	COMMENTS								
P1	WB	UC4A									
P2	WB	UC3B									
Р3	WB or OT	UC4B									

TREATMENT TYPE

USE CATEGORY

WB = WATERBORNE OT = OIL-BORNE UC3B = ABOVE GROUND - EXPOSED
UC4A = GROUND CONTACT - GENERAL USE
UC4B = GROUND CONTACT - HEAVY DUTY

GENERAL NOTE:

All construction to meet or exceed all state, local, and federal codes & requirements, including but not limited to current INDOT, ISBH, IDEM, OSHA, local requirements & codes. The drawings & specs. that make up the work of this project are interrelated & dependent on every other drawing and spec. section. The contractor shall review all other specs., drawing & addendum (if applicable) to coordinate all work that relates to this project. If an item is drawn or specified on any spec. section or drawing, it shall be as if it were part of this work and shall be provided for in the contract.

NOTES:

1. This sheet is to be: 22" X 34"



SCALE:	NTS			
DRAWN B	Y: XXX			
CHECKED BY: XXX				
DATE: X	(X			
Revision	Drawn By	Date		
FILE NO:	2312939			

CLIENT NAME: TOWN OF VERNON

PROJECT DESCRIPTION: VERNON MUSCATATUCK TRAIL

SHEET TITLE: STD\_945-10-01 BOLLARDS

DESIGN PHASE: OWNER REVIEW

# TRAIL DIRECTIONAL MARKER

-		ORMATION ORDER
	NO.	DESCRIPTION
	1	TRAIL IDENTIFICATION
	2	ARROW
	(3)	INFORMATION SIGN

BLAZE(R) AS NEEDED

	TRAIL DIRECT	IONAL MARKER	INFORMATION		SUPPORT		
TYPICAL ID	TYPE	LOCATION	LOCATION	TYPE	SIZE	QUANTITY	COMMENTS
	X	Х	Х	RPL	4x4 True	1	X


# TRAIL DIRECTIONAL MARKER INFORMATION LOCATION LOCATION ON TRAIL ON SUPPORT

	LEFT SIDE
R	RIGHT SIDE
BOTH	BOTH SIDES

FR	FRONT SIDE
ВА	BACK SIDE
BOTH	BOTH SIDES
OTHER	Х

# SUPPORT TYPE

TR	TREE
WP	WOOD POST
SP	STEEL POST
RPL	STRUCTURAL GRADE RECYCLED PLASTIC LUMBER

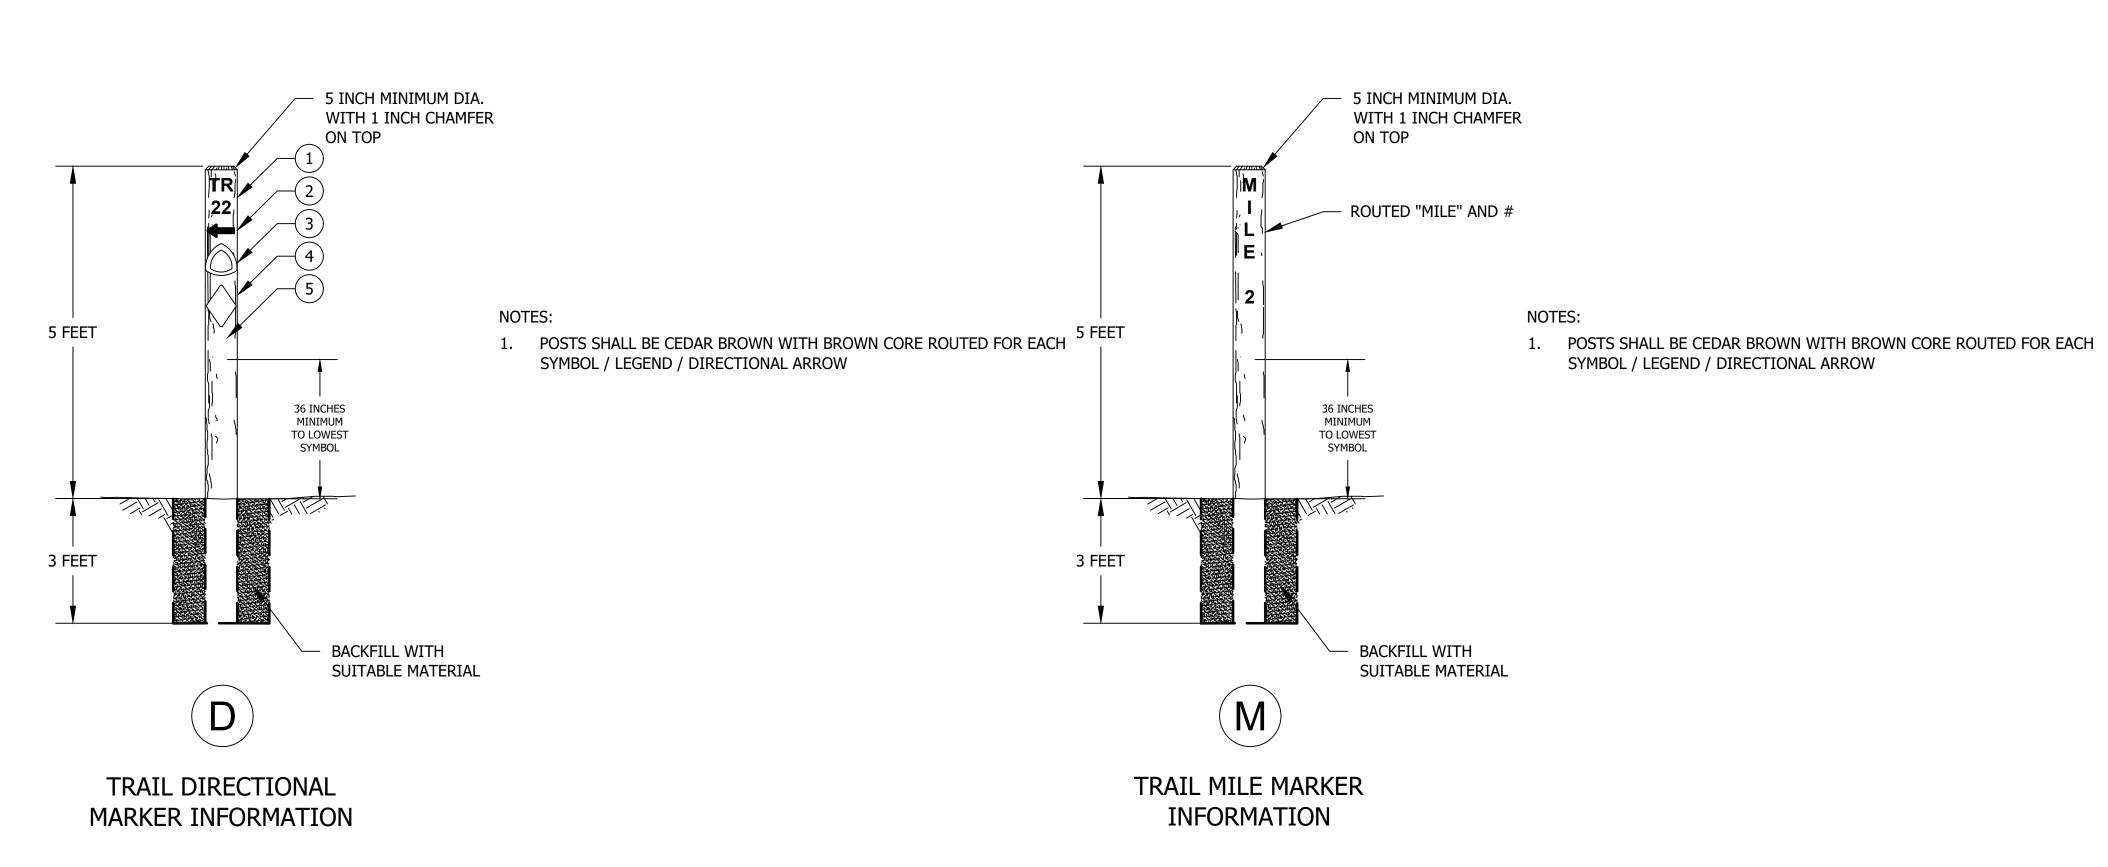

GENERAL NOTE:

All construction to meet or exceed all state, local, and federal codes & requirements, including but not limited to current INDOT, ISBH, IDEM, OSHA, local requirements & codes. The drawings & specs. that make up the work of this project are interrelated & dependent on every other drawing and spec. section. The contractor shall review all other specs., drawing & addendum (if applicable) to coordinate all work that relates to this project. If an item is drawn or specified on any spec. section or drawing, it shall be as if it were part of this work and shall be provided for in the contract.

1. This sheet is to be: 22" X 34"



SCALE: NTS
DRAWN BY: XXX
CHECKED BY: XXX
DATE: XXX
Revision Drawn By Date

FILE NO: 2312939
CLIENT NAME:
TOWN OF VERNON

PROJECT DESCRIPTION: VERNON MUSCATATUCK TRAIL


SHEET TITLE: STD 952-01

STD\_952-01 TRAIL DIRECTIONAL MARKERS

DESIGN PHASE: OWNER REVIEW

SHEET NUMBER

CD-108

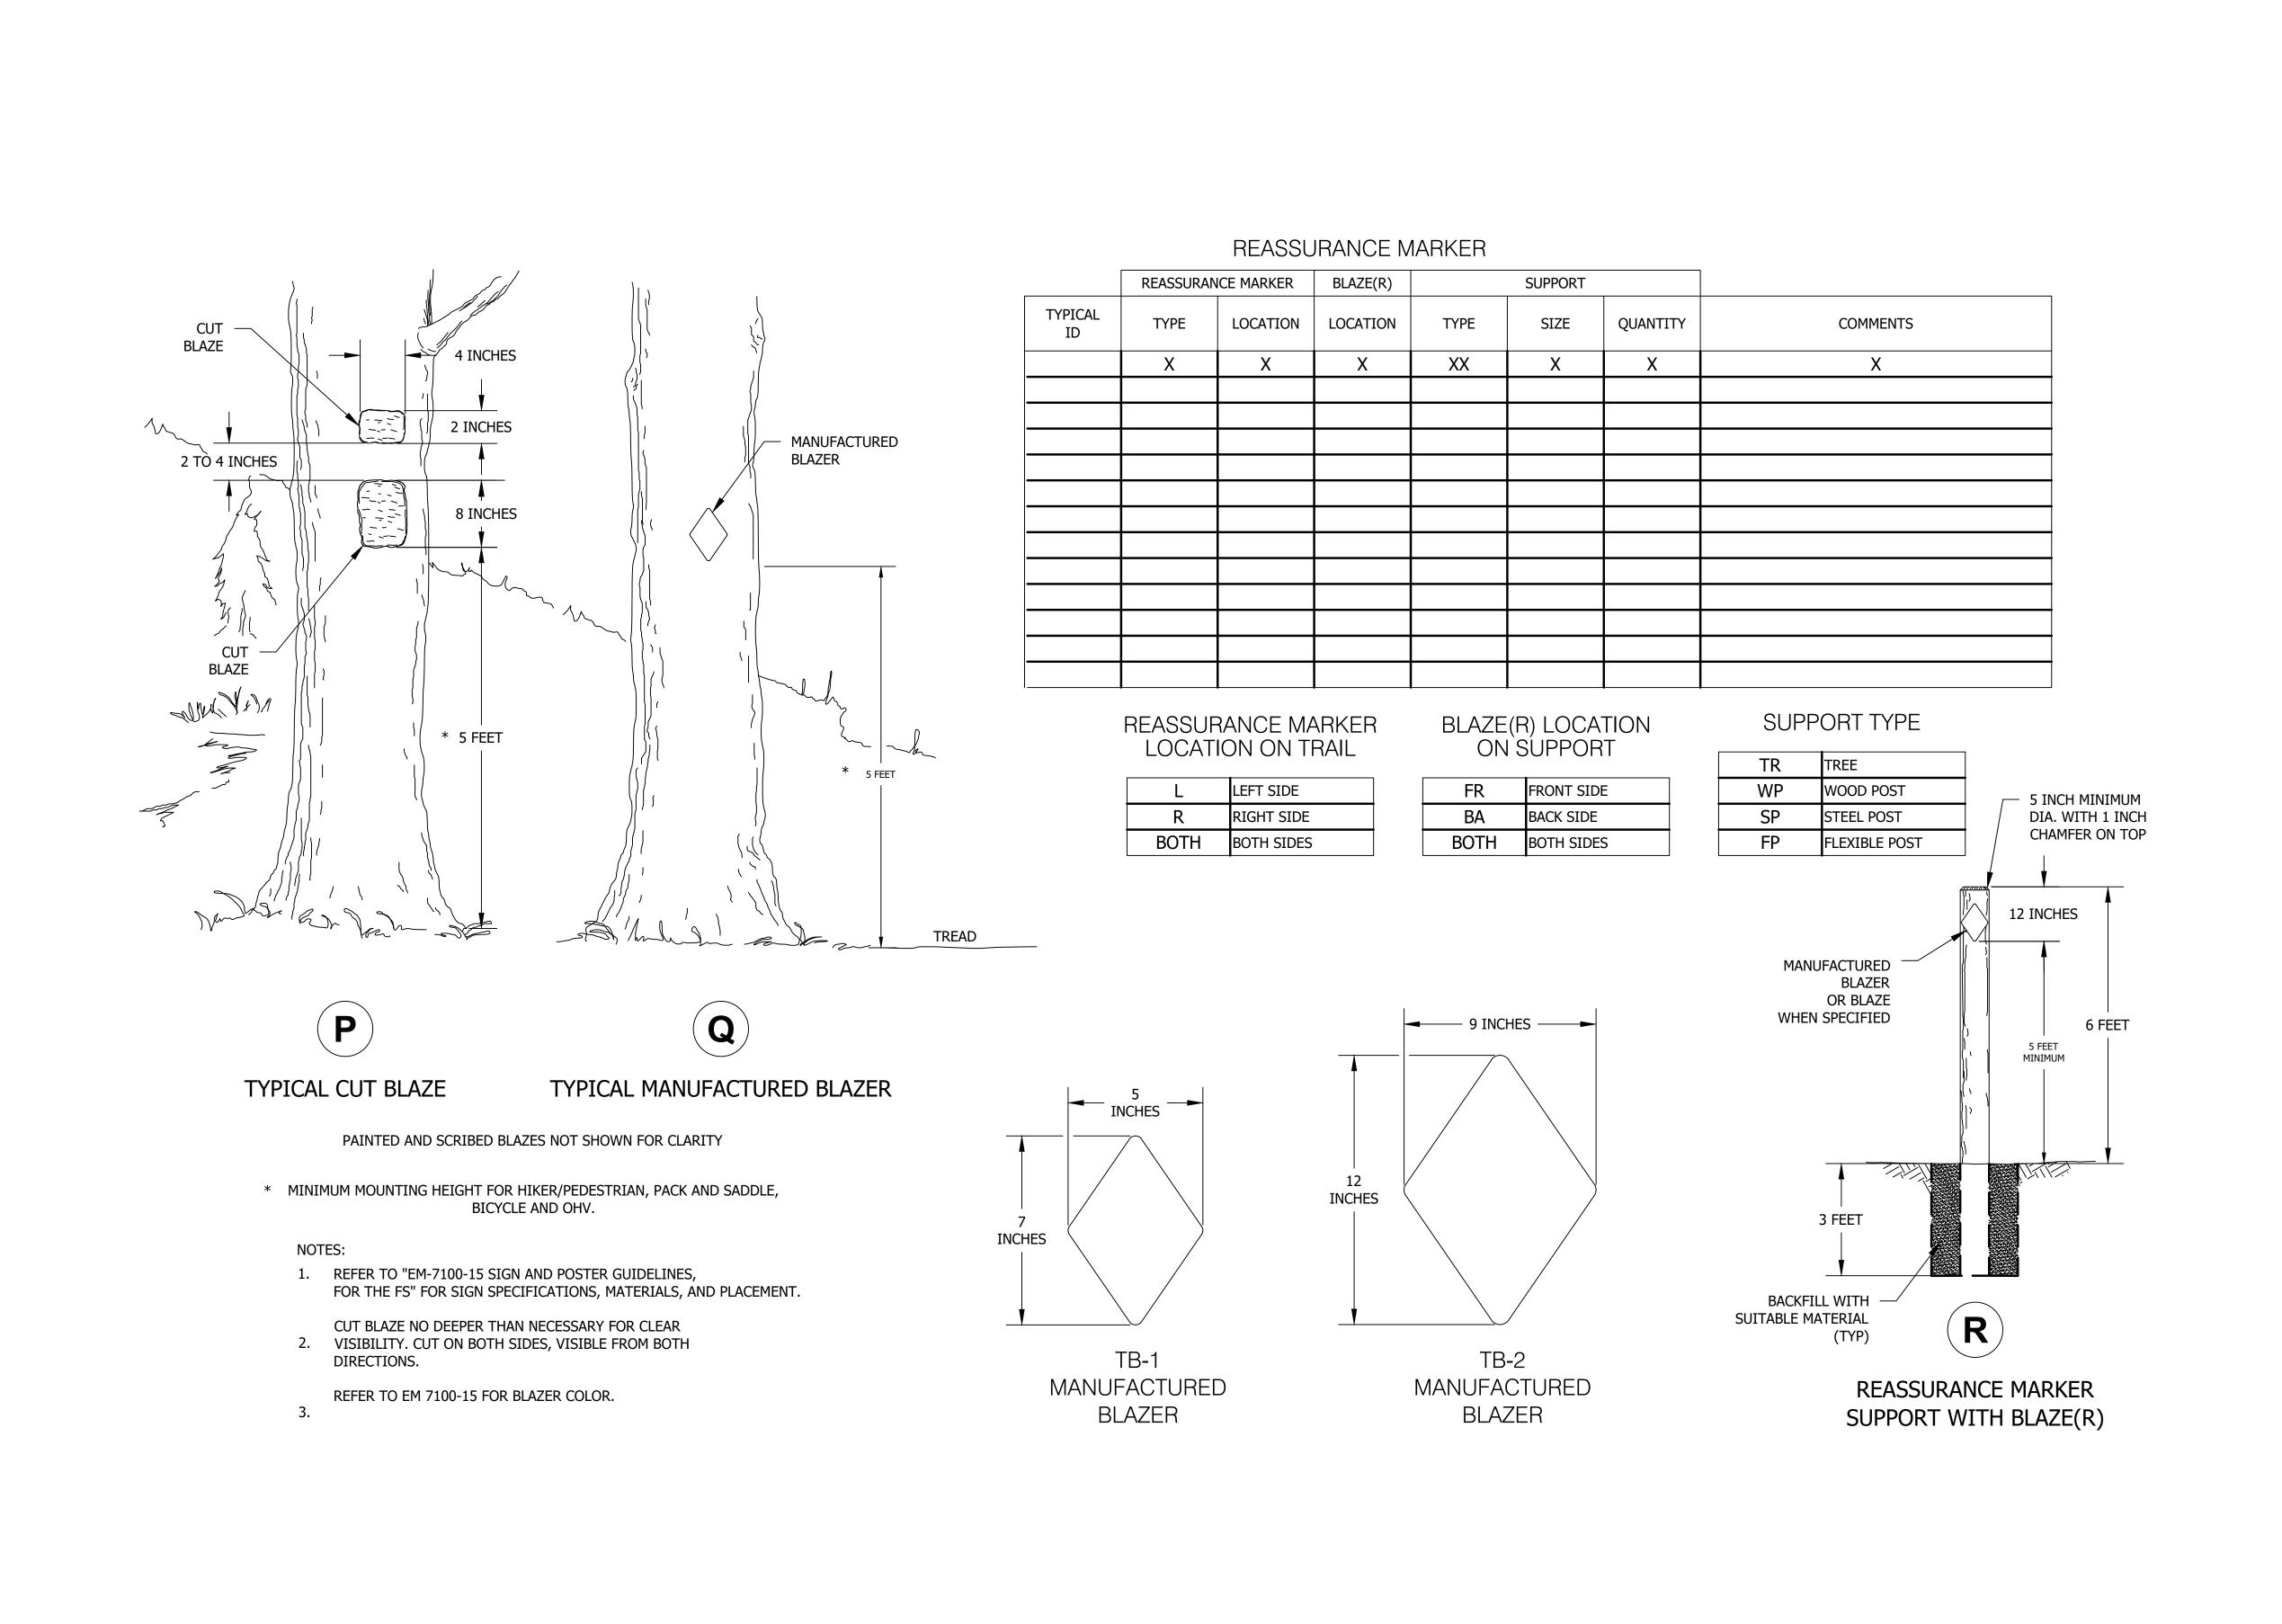

All construction to meet or exceed all state, local, and federal codes & requirements, including but not limited to current INDOT, ISBH, IDEM, OSHA, local requirements & codes. The drawings & specs. that make up the work of this project are interrelated & dependent on every other drawing and spec. section. The contractor shall review all other specs., drawing & addendum (if applicable) to coordinate all work that relates to this project. If an item is drawn or specified on any spec. section or drawing, it shall be as if it were part of this work and shall be provided for in the contract.

1. This sheet is to be: 22" X 34"



SCALE: NTS
DRAWN BY: XXX
CHECKED BY: XXX
DATE: XXX
Revision Drawn By Date


FILE NO: 2312939
CLIENT NAME:
TOWN OF VERNON


PROJECT DESCRIPTION: VERNON MUSCATATUCK TRAIL


VERNON HOSCATATO

SHEET TITLE: STD\_953-01 REASSURANCE MARKERS

DESIGN PHASE: OWNER REVIEW

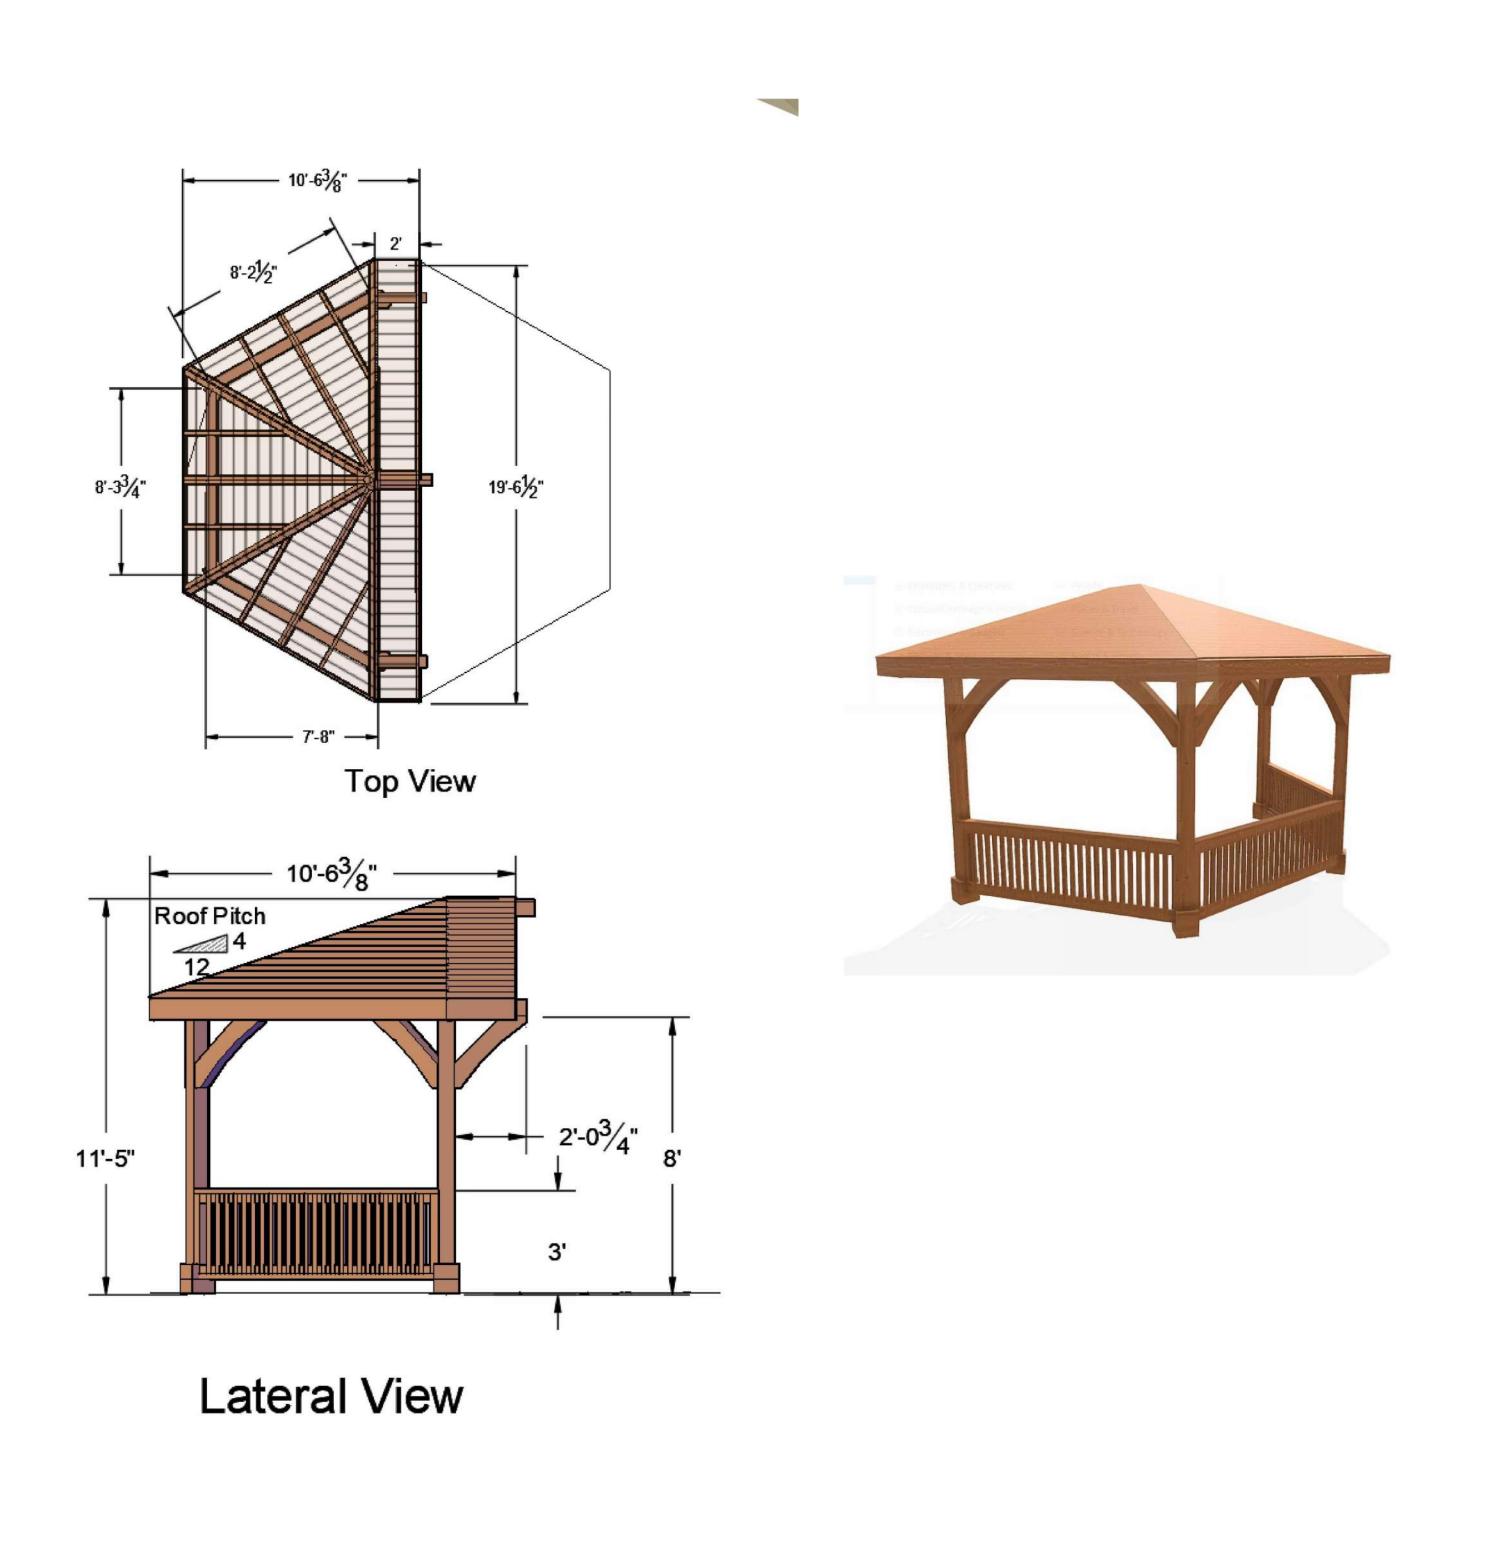

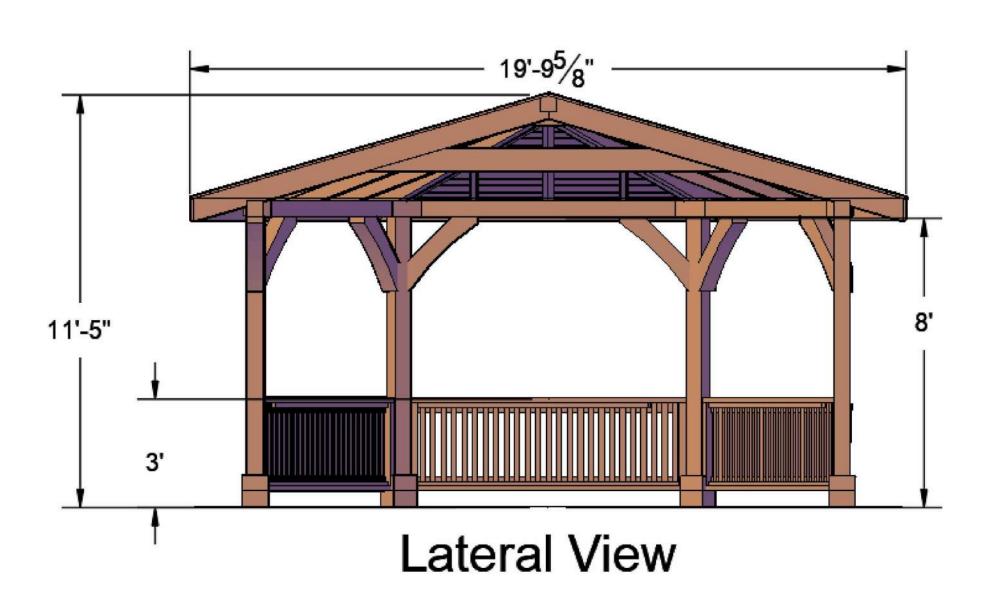

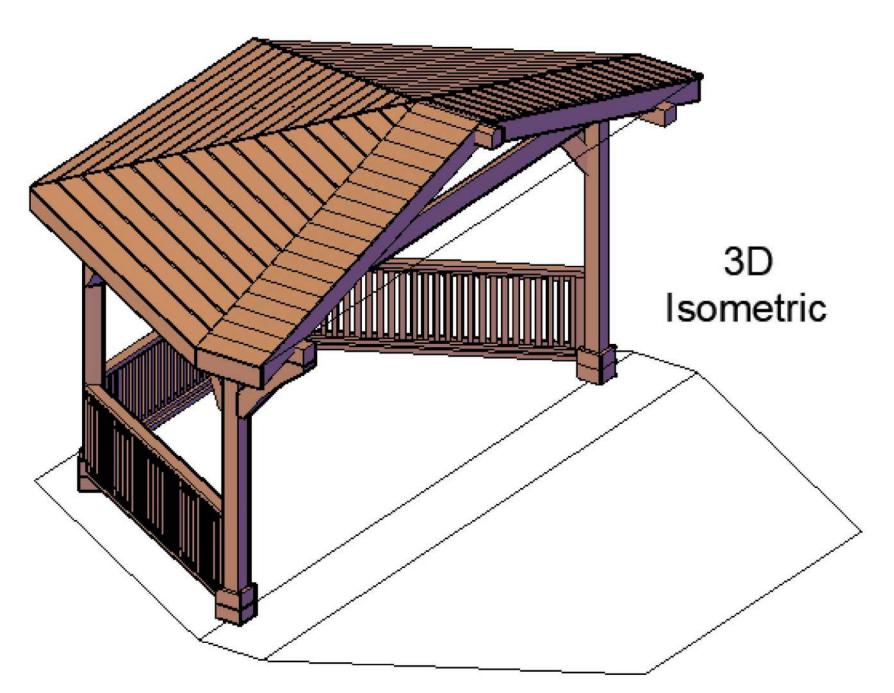

VERNON HIGH SCHOOL RIVER OVERLOOK STRUCTURE

GENERAL NOTE:

All construction to meet or exceed all state, local, and federal codes & requirements, including but not limited to current INDOT, ISBH, IDEM, OSHA, local requirements & codes. The drawings & specs. that make up the work of this project are interrelated & dependent on every other drawing and spec. section. The contractor shall review all other specs., drawing & addendum (if applicable) to coordinate all work that relates to this project. If an item is drawn or specified on any spec. section or drawing, it shall be as if it were part of this work and shall be provided for in the contract.

NOTES:

1. This sheet is to be: 22" X 34"

Engineers · Surveyors · Planners · Inspectors

Offices in North Vernon, Seymour, & New Castle

72 Henry Street, PO Box 47

North Vernon, IN 47265

PRI THE CONSTRUCTOR

SCALE: 1" = 20'

DRAWN BY: CK

CHECKED BY: SG

DATE: OCTOBER 2, 2023

Revision Drawn By Date

FILE NO: 2312939
CLIENT NAME:
TOWN OF VERNON


PROJECT DESCRIPTION: VERNON MUSCATATUCK TRAIL

SHEET TITLE: RIVER OVERLOOK STRUCTURE

DESIGN PHASE:

OWNER REVIEW

CD-110

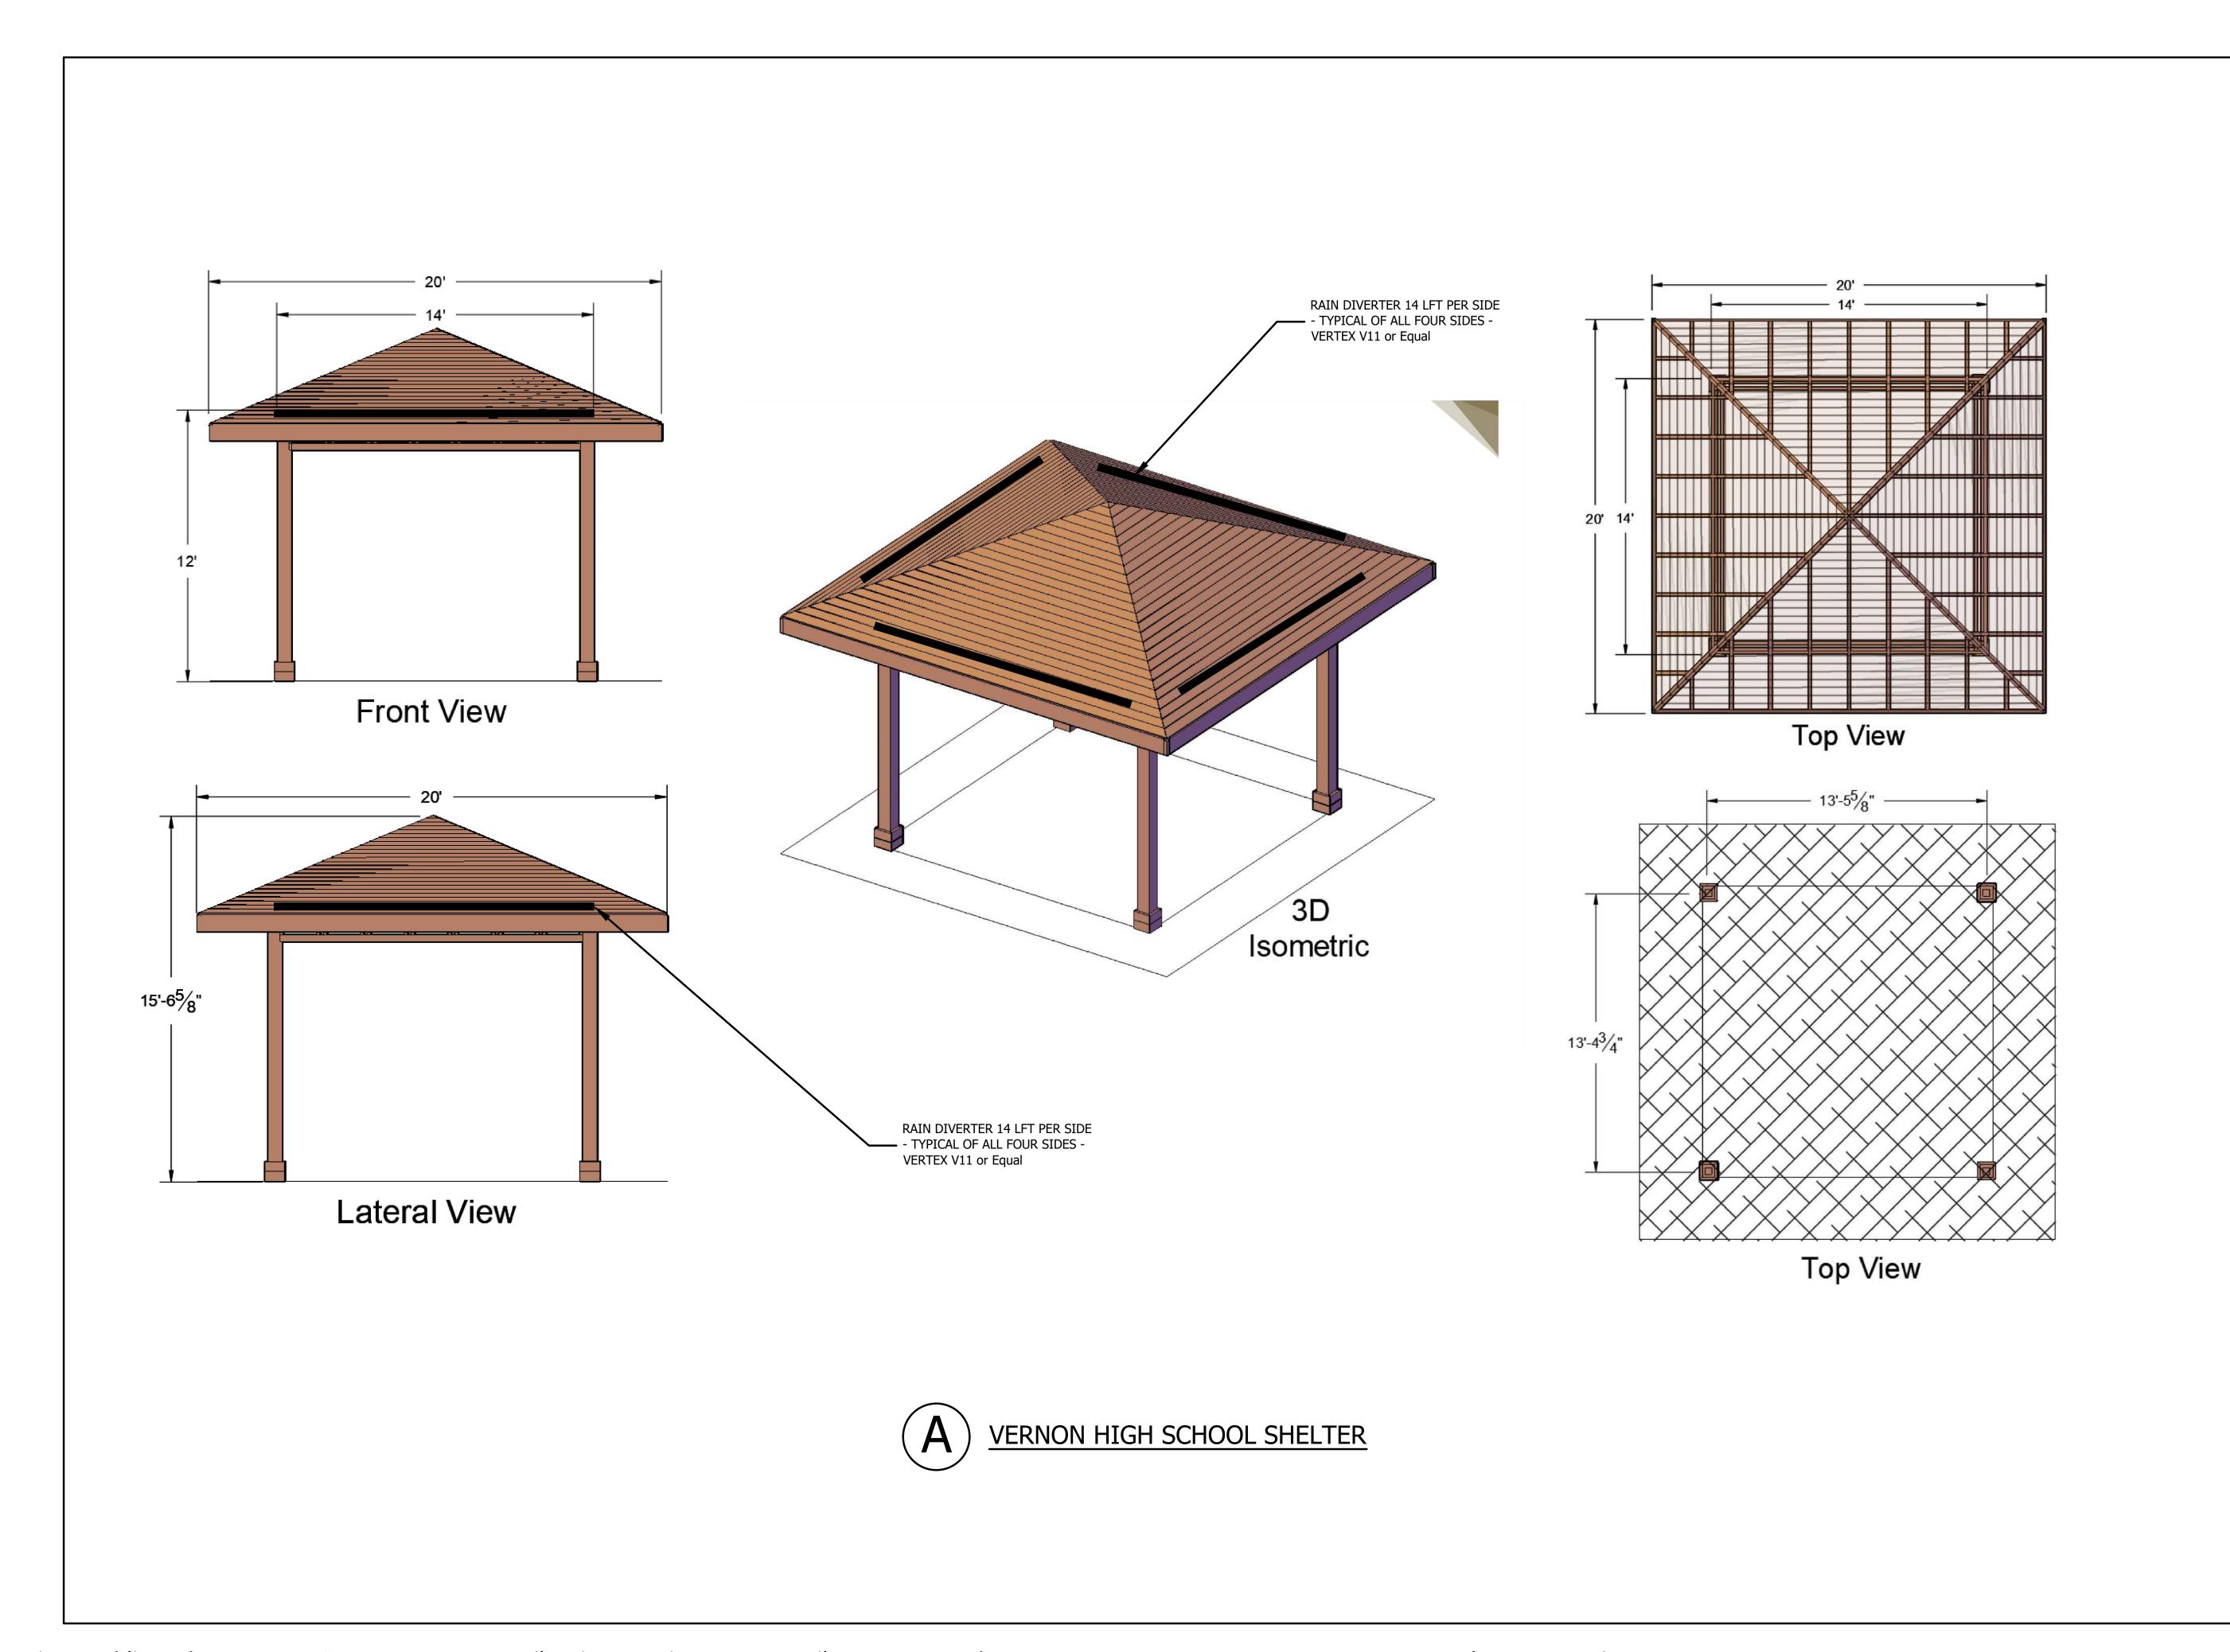

All construction to meet or exceed all state, local, and federal codes & requirements, including but not limited to current INDOT, ISBH, IDEM, OSHA, local requirements & codes. The drawings & specs. that make up the work of this project are interrelated & dependent on every other drawing and spec. section. The contractor shall review all other specs. all other specs., drawing & addendum (if applicable) to coordinate all work that relates to this project. If an item is drawn or specified on any spec. section or drawing, it shall be as if it were part of this work and shall be provided for in the contract.

NOTES:

1. This sheet is to be: 22" X 34"




SCALE: 1" = 20' DRAWN BY: CK CHECKED BY: SG DATE: OCTOBER 2, 2023 Revision Drawn By Date

FILE NO: 2312939 CLIENT NAME: TOWN OF VERNON

PROJECT DESCRIPTION: VERNON MUSCATATUCK TRAIL

SHEET TITLE: VERNON HIGH SCHOOL SHELTER

DESIGN PHASE:

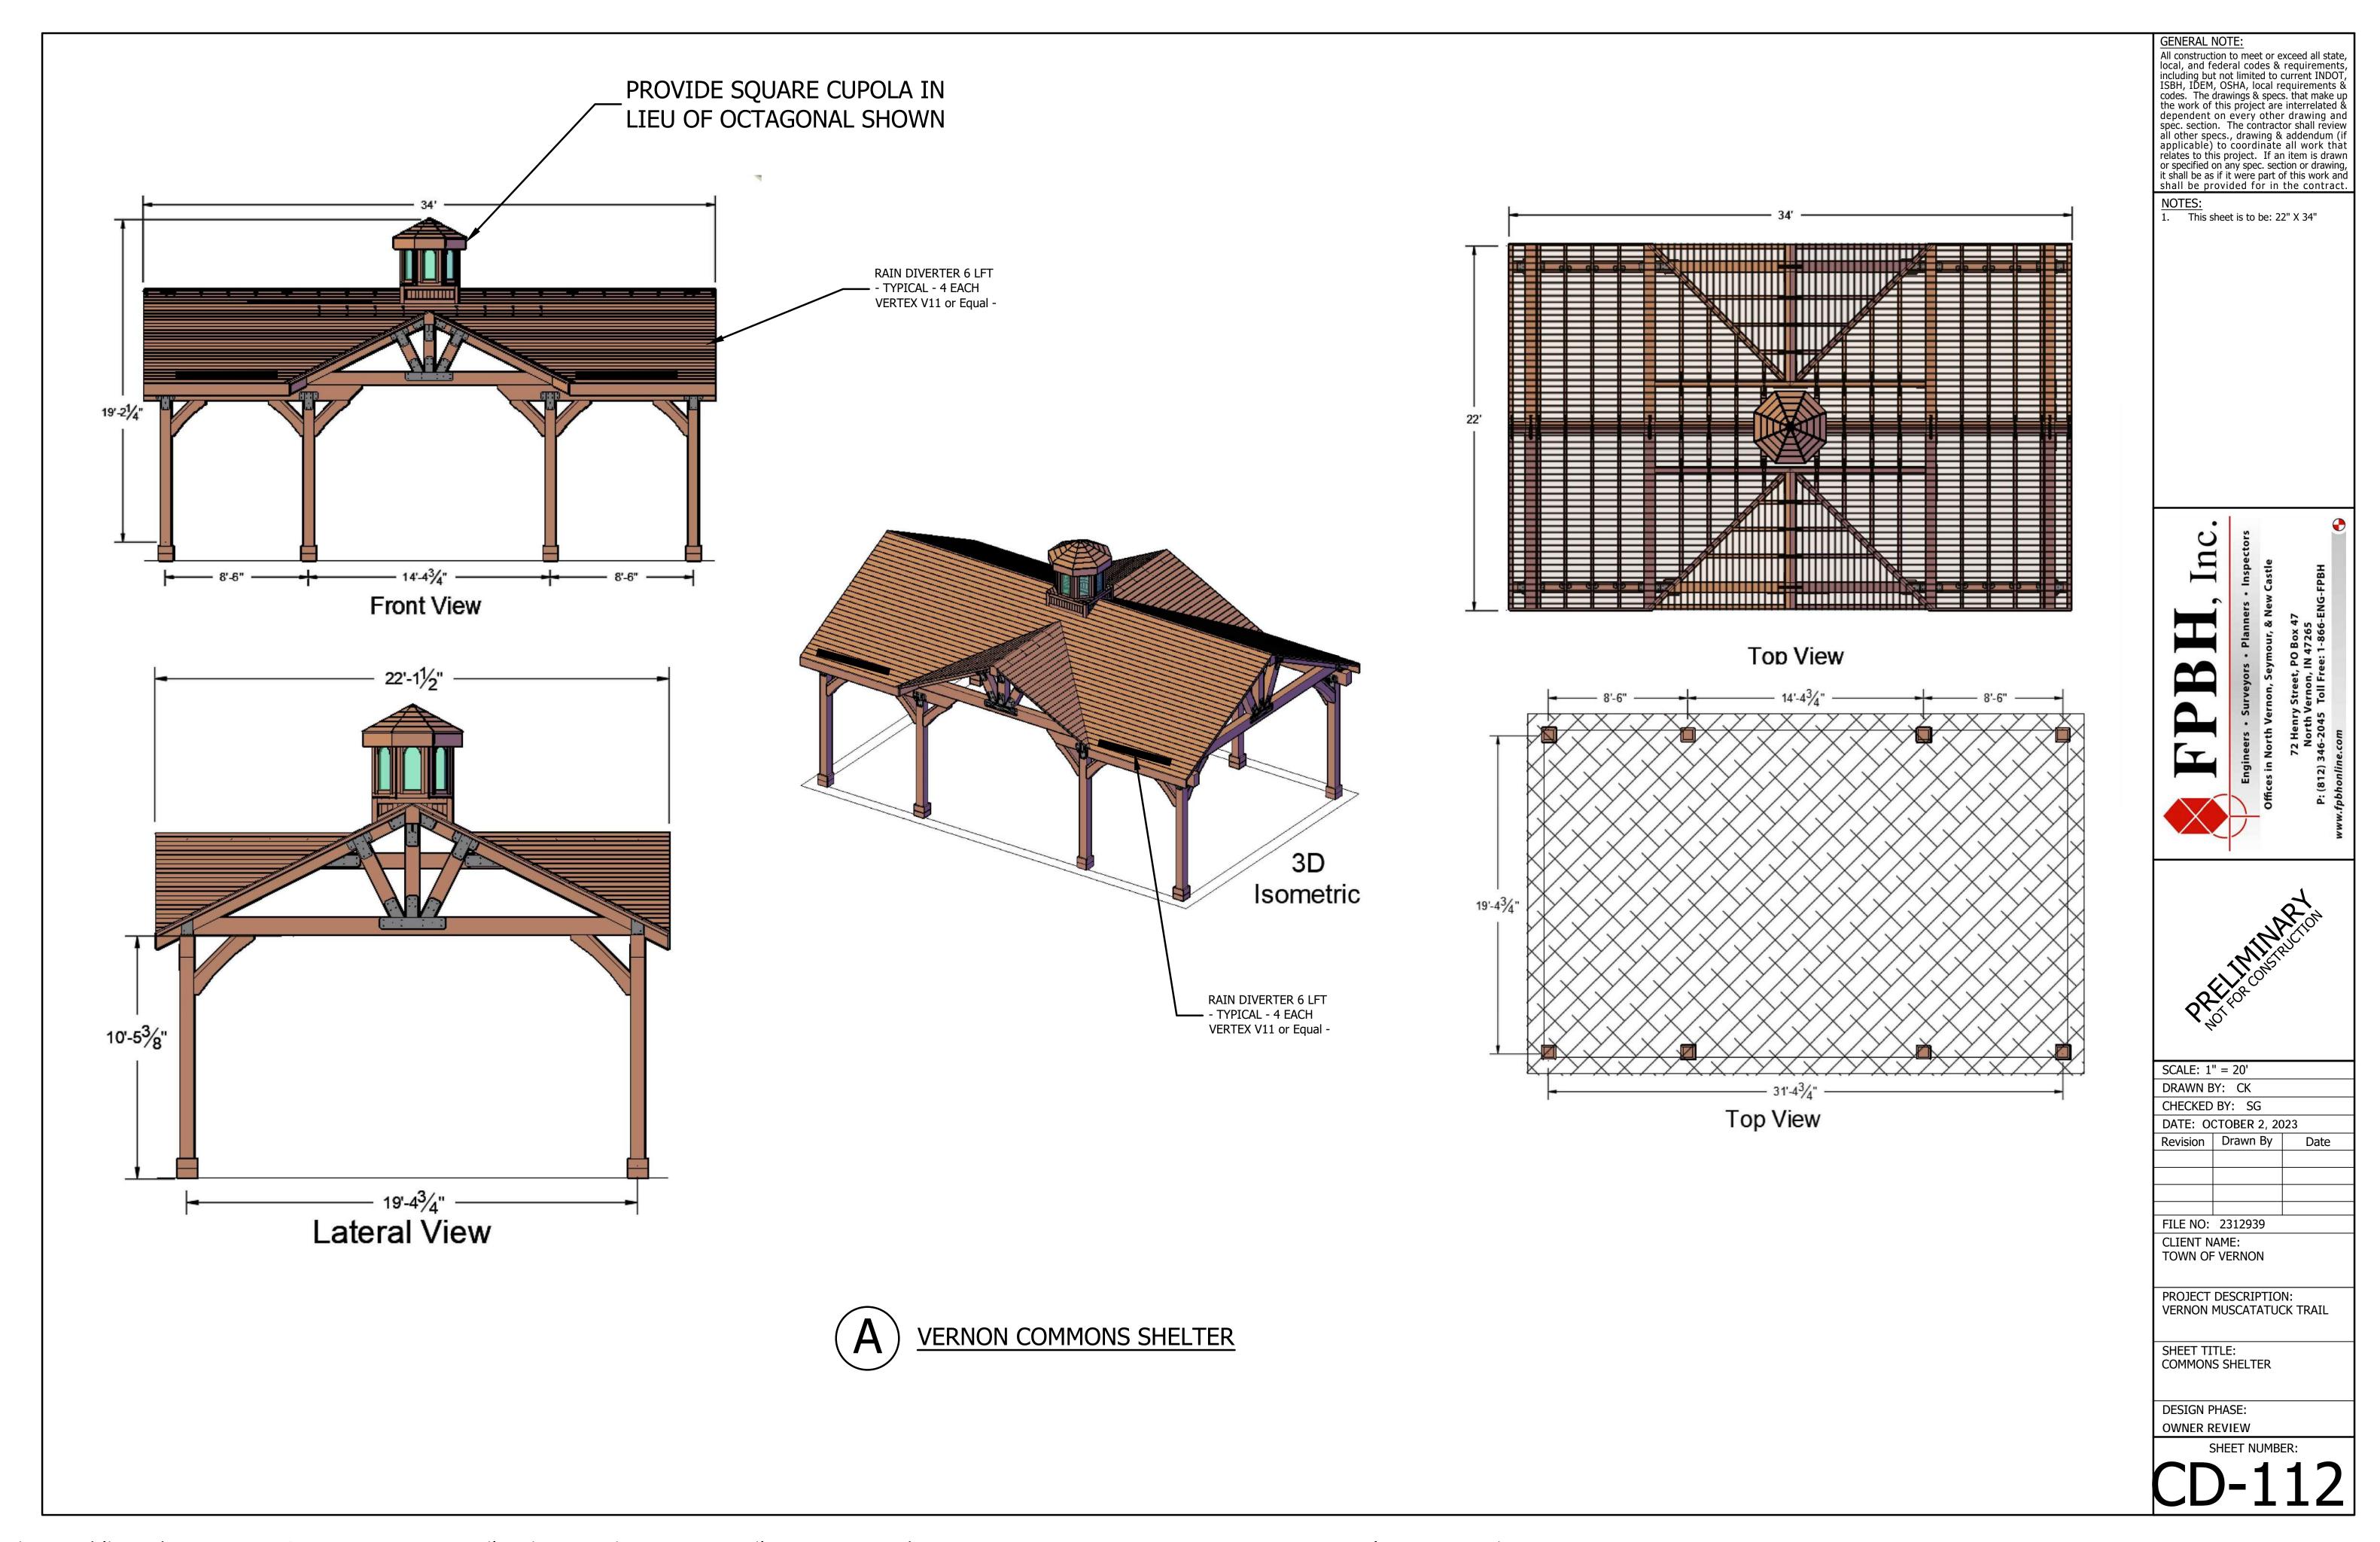



(A) KIOSK - TYPICAL DESIGN CONCEPT

All construction to meet or exceed all state, local, and federal codes & requirements, including but not limited to current INDOT, ISBH, IDEM, OSHA, local requirements & codes. The drawings & specs. that make up the work of this project are interrelated & dependent on every other drawing and spec. section. The contractor shall review all other specs., drawing & addendum (if applicable) to coordinate all work that relates to this project. If an item is drawn or specified on any spec. section or drawing, it shall be as if it were part of this work and shall be provided for in the contract.

1. This sheet is to be: 22" X 34"



SCALE: 1" = 20'

DRAWN BY: CK

CHECKED BY: SG

DATE: OCTOBER 2, 2023

Revision Drawn By Date

FILE NO: 2312939 CLIENT NAME: TOWN OF VERNON


PROJECT DESCRIPTION: VERNON MUSCATATUCK TRAIL

SHEET TITLE: TRAIL KIOSK

DESIGN PHASE: OWNER REVIEW

SHEET NUMBE

CD-113

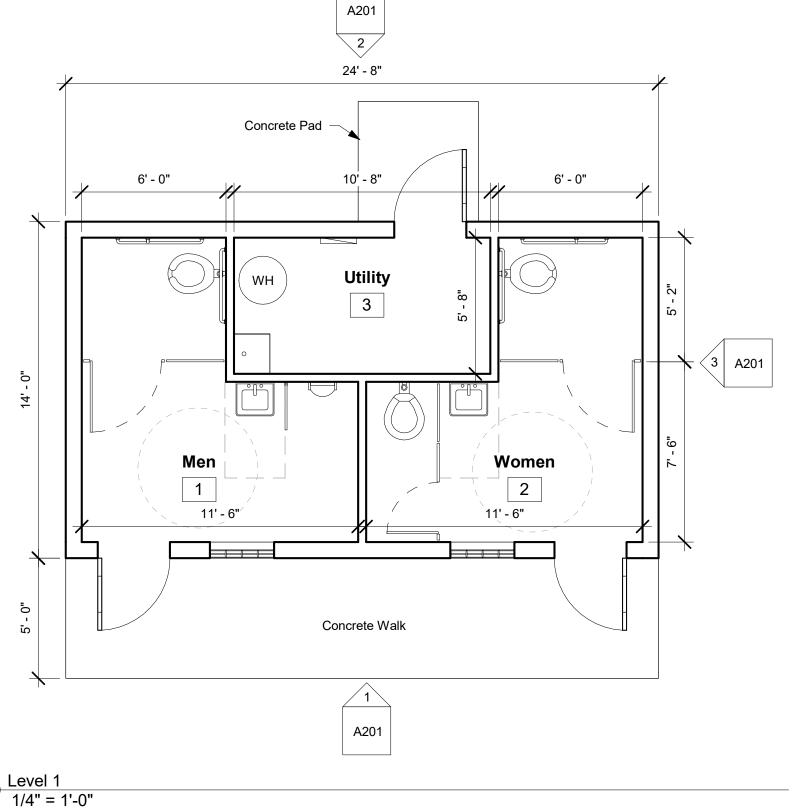


- Exterior walls to be 8" CMU w/ fiber cement siding.
  Interior walls to be 4" CMU (All interior wall surfaces to be painted).
  Ceiling to have FRP finish.
- Floor to be 4" sealed concrete slab on grade w/ floor drains in each room.
- All hardware and fixtures to be ADA compliant.

SHEET NO: A101


M 4

Inc.

All lighting to be LED.
Plumbing winterization valves to be installed.
Provide a lockable hose bib in each restroom below lavatory.
Water closet and urinal partitions to be metal with baked enamel finish. 14' - 0" 5' - 0"

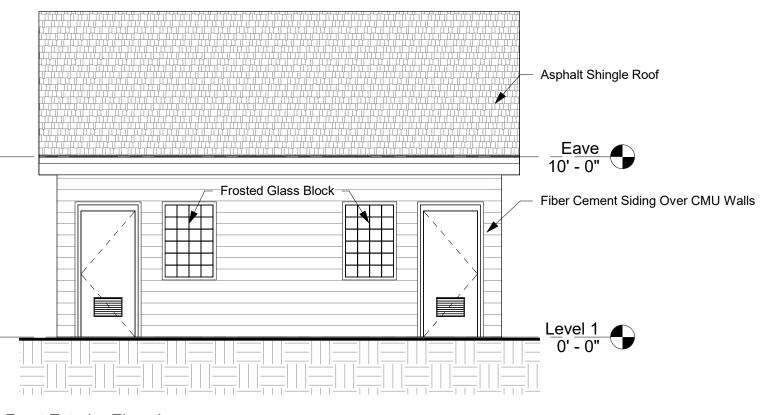

Front Exterior Elevation 3/16" = 1'-0"

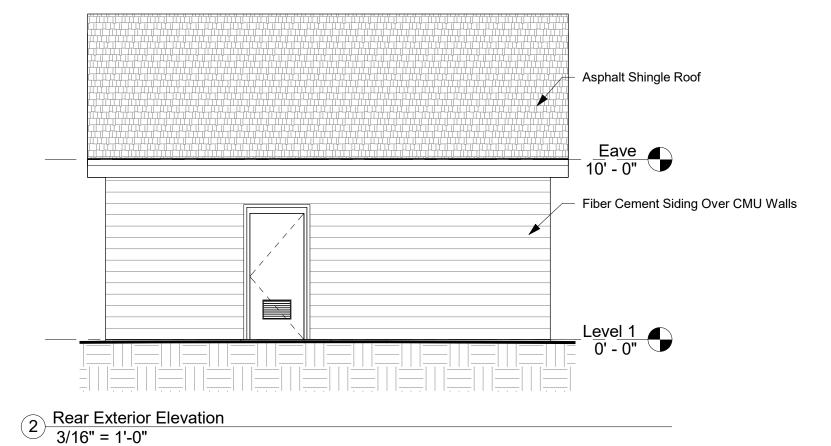

1'-0" 1'-0" Eave 10' - 0" Level 1 0' - 0"

Side Exterior Elevation 3/16" = 1'-0"

Inc.

M

4

DRAWN BY: TDW CHECKED BY: BAH JOB NO: 23-12939

SHEET NO: A201